DEMOCRATIC SOCIALIST REPUBLIC OF SRI LANKA

STATE MINISTRY OF NATIONAL SECRURITY, HOME AFFAIRS AND DISASTER MANAGEMENT



NATIONAL BUILDING RESEARCH ORGANISATION




REDUCTION OF LANDSLIDE VULNERABILITY BY MITIGATION MEASURES

LAND SLIDE MITIGATION WORKS IN LANDSLIDE MITIGATION WORKS IN COLOMBO, GAMPAHA, KEGALLE & KURUNEGALA DISTRICTS

PACKAGE NO: RLVMMP/WORKS/04A

DETAILED DESIGN DRAWINGS

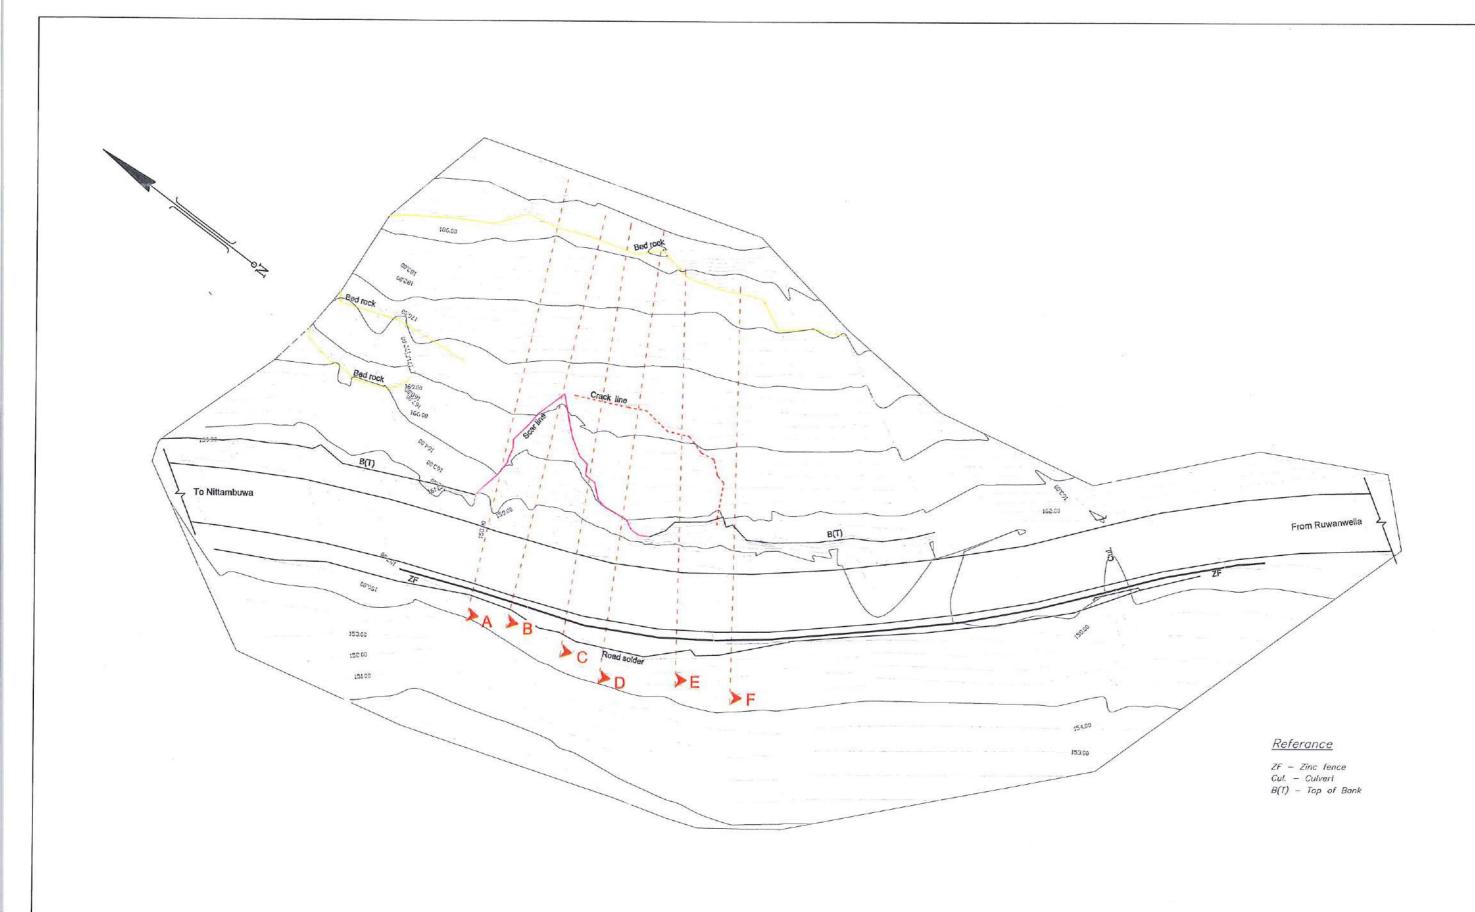

EMPLOYER

DEMOCRATIC SOCIALIST REPUBLIC OF SRI LANKA

STATE MINISTRY OF INTERNAL SECURITY, HOME AFFAIRS
AND DISASTER MANAGEMENT

NATIONAL BUILDING RESEARCH ORGANIZATION
No. 99/1 "JAWATTA ROAD

COLOMBO - 05

DESIGNER

DESIGN UNIT
NATIONAL BUILDING RESEARCH ORGANIZATION
No. 99/1 ,JAWATTA ROAD
COLOMBO - 05


REV DATE REVISION DESCRIPTION APPROVAL PROJECT TITLE

REDUCTION OF LANDSLIDE


VULNERABILITY BY MITIGATION MEASURES

BETWEEN Ch 15+740 - Ch 15+790

VEYANGODA - RUWANWELLA ROAD

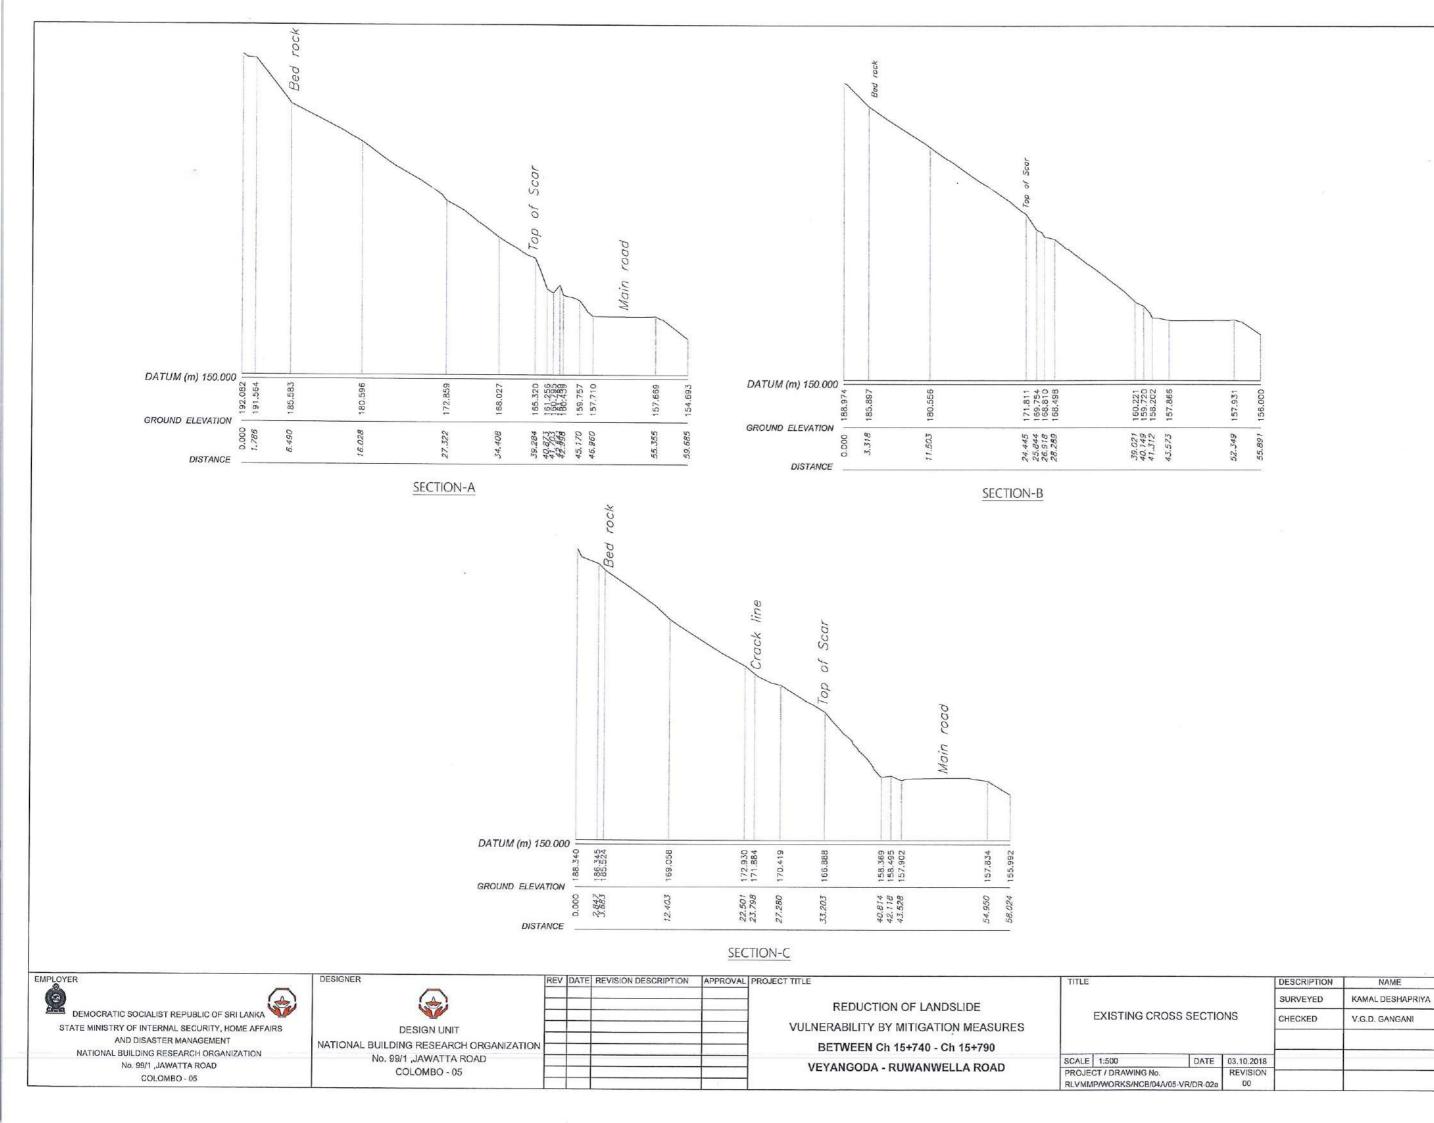

SIGNATURE

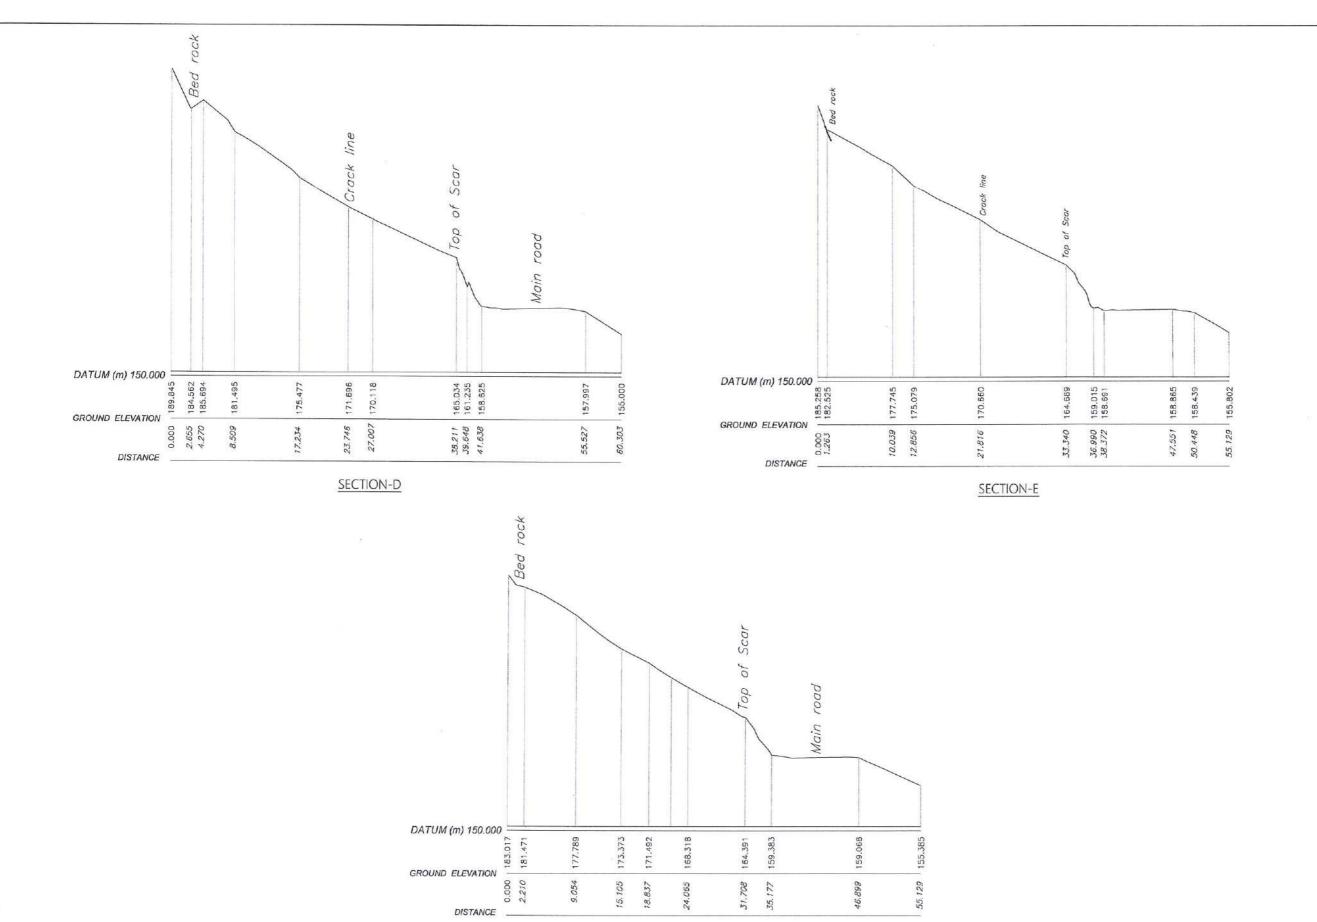

EMPLOYER DEMOCRATIC SOCIALIST REPUBLIC OF SRI LANKA STATE MINISTRY OF INTERNAL SECURITY, HOME AFFAIRS AND DISASTER MANAGEMENT

NATIONAL BUILDING RESEARCH ORGANIZATION No. 99/1 ,JAWATTA ROAD COLOMBO - 05

DESIGNER

DESIGN UNIT NATIONAL BUILDING RESEARCH ORGANIZATION No. 99/1 ,JAWATTA ROAD COLOMBO - 05

REV DATE REVISION DESCRIPTION | APPROVAL PROJECT TITLE

SECTION-F


REDUCTION OF LANDSLIDE VULNERABILITY BY MITIGATION MEASURES BETWEEN Ch 15+740 - Ch 15+790 VEYANGODA - RUWANWELLA ROAD


DESCRIPTION NAME KAMAL DESHAPRIYA SURVEYED EXISTING CROSS SECTIONS

RLVMMP/WORKS/NCB/04A/05-VR/DR-02b

V.G.D. GANGANI SCALE 1:500 PROJECT / DRAWING No. DATE 03.10.2018

SIGNATURE

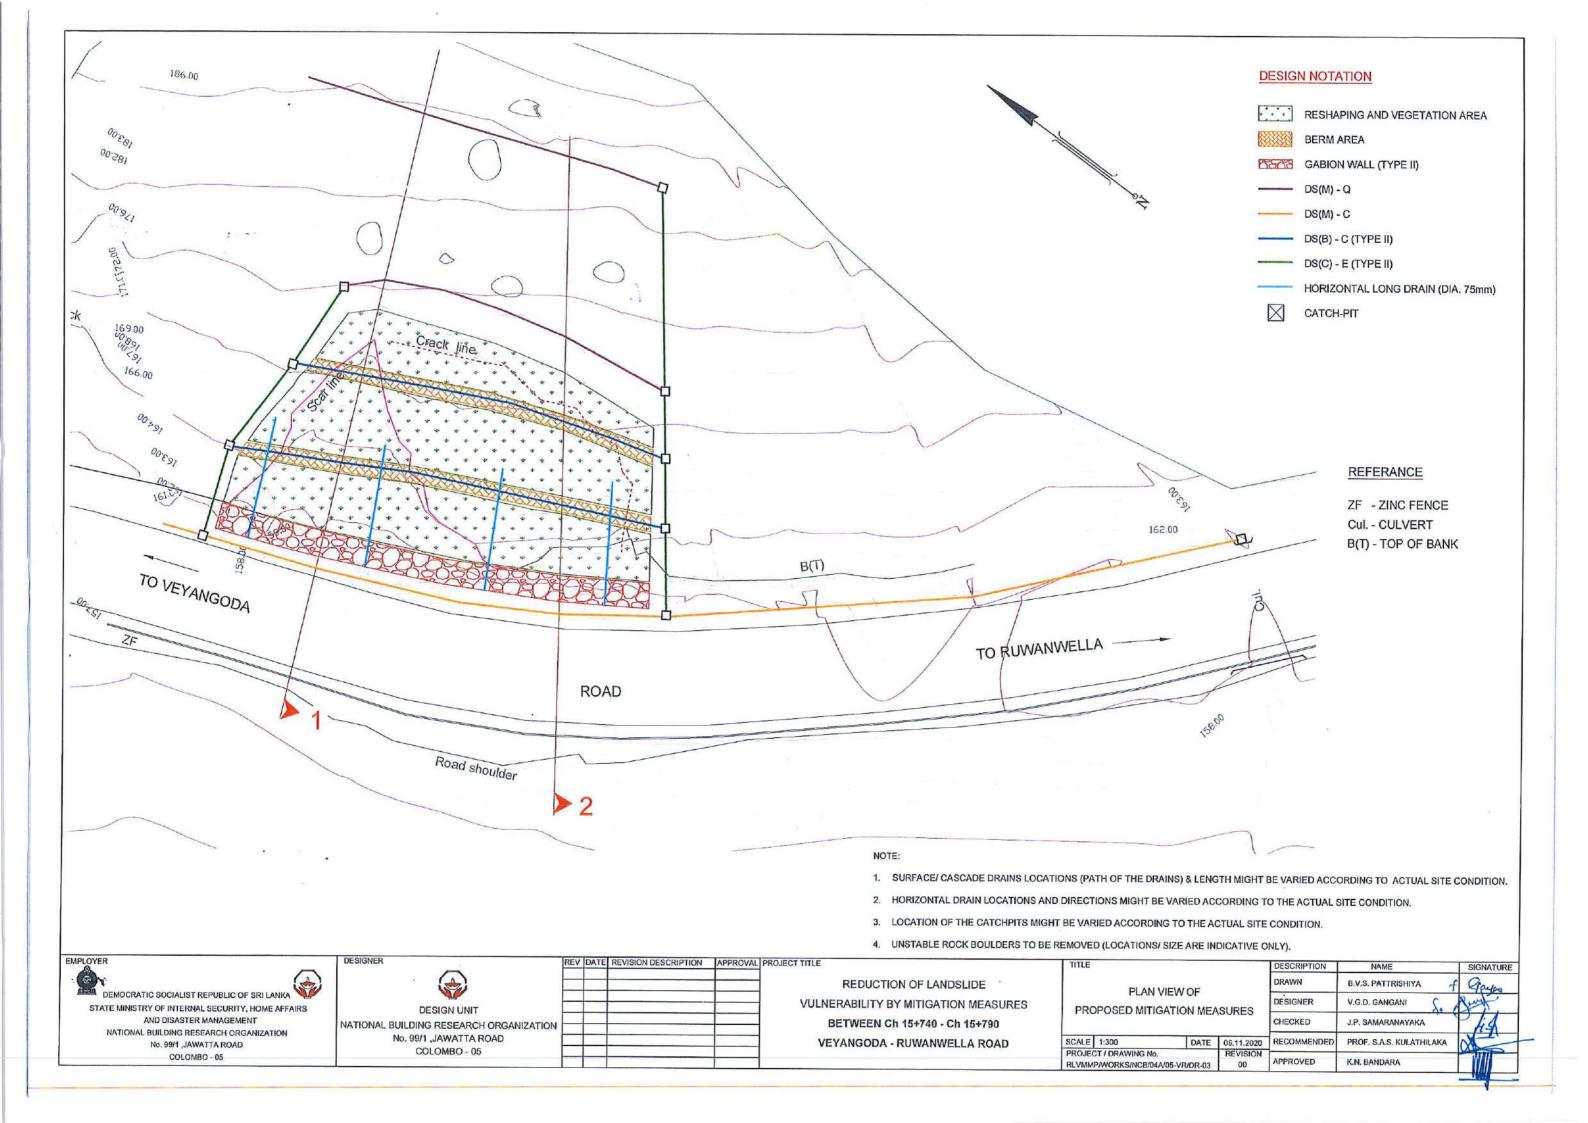

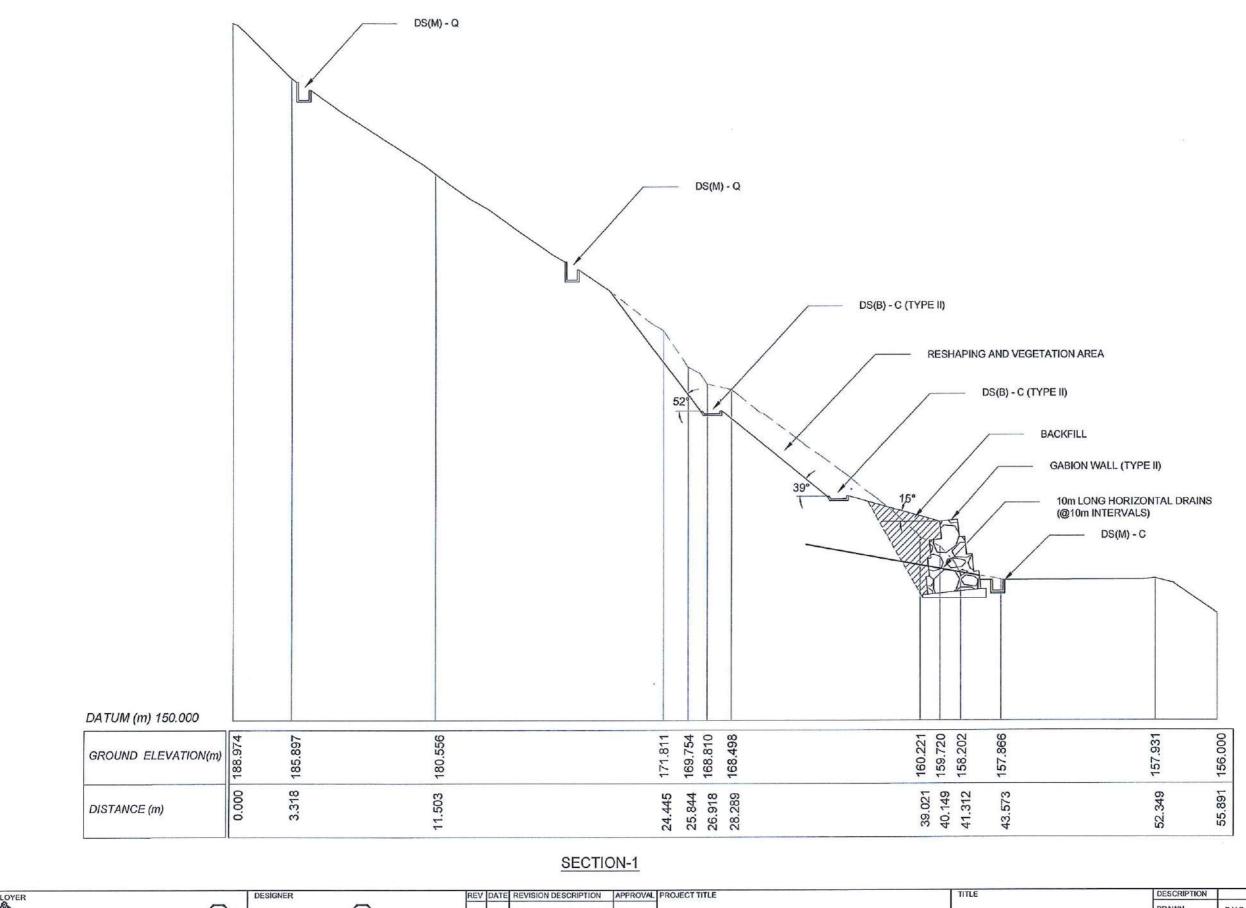

DEMOCRATIC SOCIALIST REPUBLIC OF SRI LANKA STATE MINISTRY OF INTERNAL SECURITY, HOME AFFAIRS AND DISASTER MANAGEMENT

NATIONAL BUILDING RESEARCH ORGANIZATION No. 99/1 ,JAWATTA ROAD COLOMBO - 05

DESIGN UNIT NATIONAL BUILDING RESEARCH ORGANIZATION No. 99/1 ,JAWATTA ROAD COLOMBO - 05

REDUCTION OF LANDSLIDE VULNERABILITY BY MITIGATION MEASURES BETWEEN Ch 15+740 - Ch 15+790 VEYANGODA - RUWANWELLA ROAD


| CROSS SECTIONS OF |
|------------------------------|
| PROPOSED MITIGATION MEASURES |
| |

SCALE 1:200

PROJECT / DRAWING No

RLVMMP/WORKS/NCB/04A/05-VR/DR-048

B.V.S. PATTRISHIYA DESIGNER V.G.D. GANGANI J.P. SAMARANAYAKA CHECKED PROF. S.A.S. KULATHILAKA RECOMMENDED DATE 06.11.2020 REVISION K.N. BANDARA APPROVED 00

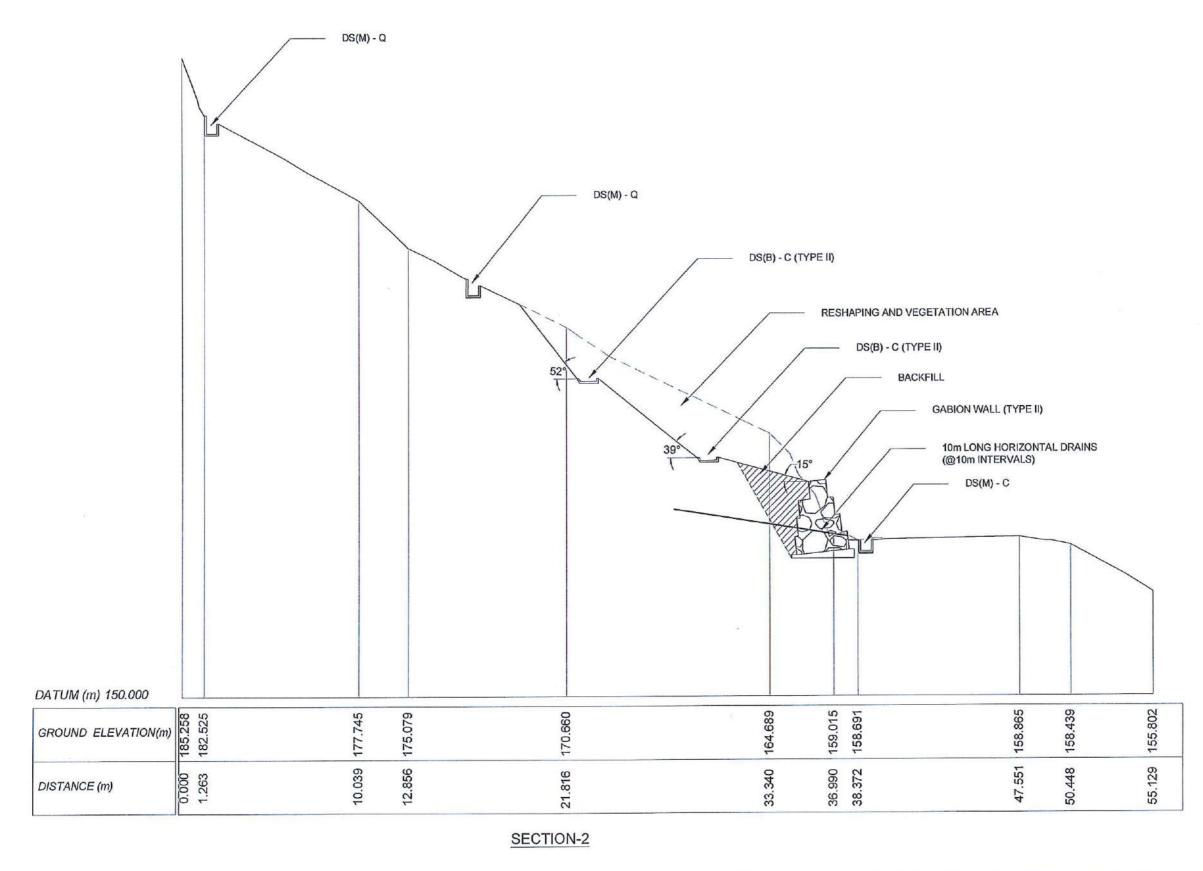

DEMOCRATIC SOCIALIST REPUBLIC OF SRI LANKA

STATE MINISTRY OF INTERNAL SECURITY, HOME AFFAIRS
AND DISASTER MANAGEMENT
NATIONAL BUILDING RESEARCH ORGANIZATION
No. 99/1, JAWATTA ROAD
COLOMBO - 05

EMPLOYER

DESIGNER

DESIGN UNIT

NATIONAL BUILDING RESEARCH ORGANIZATION

No. 99/1 ,JAWATTA ROAD

COLOMBO - 05

REV DATE REVISION DESCRIPTION | APPROVAL PROJECT TITLE


REDUCTION OF LANDSLIDE

VULNERABILITY BY MITIGATION MEASURES


BETWEEN Ch 15+740 - Ch 15+790


VEYANGODA - RUWANWELLA ROAD

| TITLE | | | | DESCRIPTION | NAME | SIGNATURI |
|---|------------|------|----------------|-------------------|--------------------------|-----------|
| | | | | DRAWN | B.V.S. PATTRISHIYA | Carpo |
| 55.5 | CROSS SECT | | | DESIGNER | V.G.D. GANGANI | And! |
| PROPOSED MITIGATION MEASURES | | | CHECKED | J.P. SAMARANAYAKA | Judi | |
| SCALE | 1:200 | DATE | 06.11.2020 | RECOMMENDED | PROF. S.A.S. KULATHILAKA | ON THE |
| PROJECT / DRAWING No. REVISION RLVMMP/WORKS/NCB/04A/05-VR/DR-04b 00 | | | REVISION 00 | APPROVED | K.N. BANDARA | |

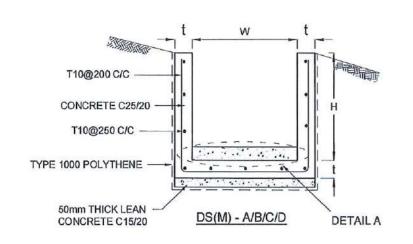

| DRAIN TYPE | W (mm) | H (mm) | t (mm) |
|---------------|--------|--------|--------|
| DS (M) - A /P | 300 | 300 | 100 |
| DS (M) - B/R | 450 | 450 | 100 |
| DS (M) - C/Q | 600 | 600 | 100 |
| DS (M) - D | 750 | 750 | 125 |
| DS (M) - E | 900 | 900 | 150 |
| DS (M) - F | 1000 | 1000 | 150 |

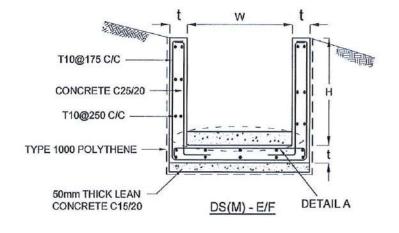

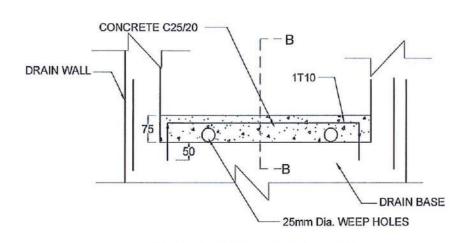

DETAIL A - (ENERGY BREAKER AT 3M)

NOTES


- DEPTH OF EXCAVATION MAY VARY ACCORDING TO SITE CONDITIONS
- STEPS SHALL BE CONSTRUCTED AT SURFACE DRAIN ON SLOPING 2. GROUND ACCORDING TO THE SITE CONDITIONS AS INSTRUCTED BY
- ENERGY BREAKERS SHALL BE CONSTRUCTED AT THE STEEP DRAIN SEGMENTS AS PER THE INSTRUCTIONS OF THE ENGINEER.
- DOWELS SHALL BE INSTALLED ACCORDING TO THE GROUND CONDITIONS AS INSTRUCTED BY THE ENGINEER.
- ALL DIMENSIONS ARE IN MILLIMETERS UNLESS OTHERWISE STATED. 5.
- 10 mm THICK EXPANSION JOINT SHALL BE INTRODUCED IN EVERY 5m INTERVAL.


CONCRETE


- 7. USE FOLLOWING CONCRETE GRADES FOR STRUCTURE
 - SCREED [b]
 - WALLS / BASE / ENERGY BREAKERS - C. 25/20


REINFORCEMENT

- ALL BARS MARKED "T" SHALL BE HIGH YIELD DEFORMED BARS OF YIELD STRENGTH NOT LESS THAN 460N/mm².
- BARS OF CUT LENGTH LARGER THAN THE SUPPLIED LENGTH TO BE LAPPED FOR A LENGTH OF 50 x BAR DIA, AND LAPPING SHOULD BE STAGGERED.
- ANCHORAGE LENGTH SHOULD BE 40X BAR DIA.
- 11. REINFORCEMENT BARS SHALL BE BENT IN ACCORDANCE WITH STANDARD SPECIFICATIONS.
- 12. COVER TO REINFORCEMENT
 - BURIED FACES AND DRAIN INVERTS - 40 mm
 - [b] ALL OTHER FACES - 25 mm

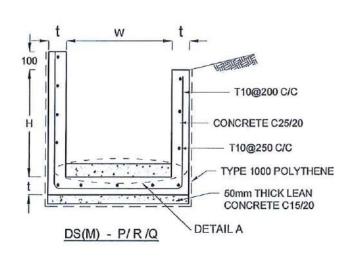

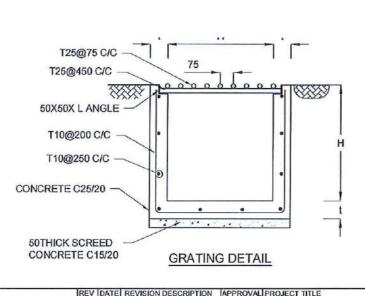

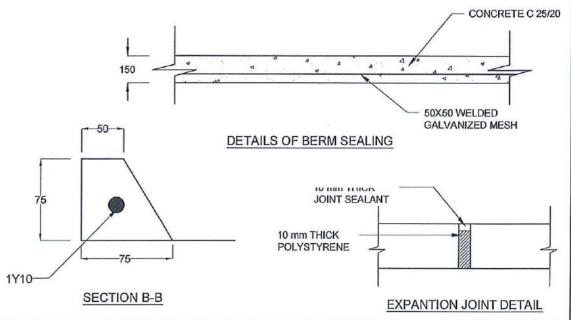

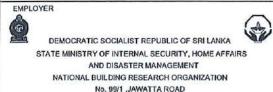



COLOMBO - 05





REDUCTION OF LANDSLIDE **VULNERABILITY BY MITIGATION MEASURES** BETWEEN Ch 15+740 - Ch 15+790 VEYANGODA - RUWANWELLA ROAD

DESCRIPTION SIGNATURE DRAWN B.V.S. PATTRISHIYA f Caya DETAILS OF DRAINS (SURFACE DRAIN -1 OF 2) DESIGNER V.G.D. GANGANI CHECKED J.P. SAMARANAYAKA RECOMMENDE PROF. S.A.S. KULATHILAKA SCALE N.T.S. DATE 06.11.2020 PROJECT / DRAWING No REVISION APPROVED K.N. BANDARA RLVMMP/WORKS/NCB/04A/05-VR/DR-05a

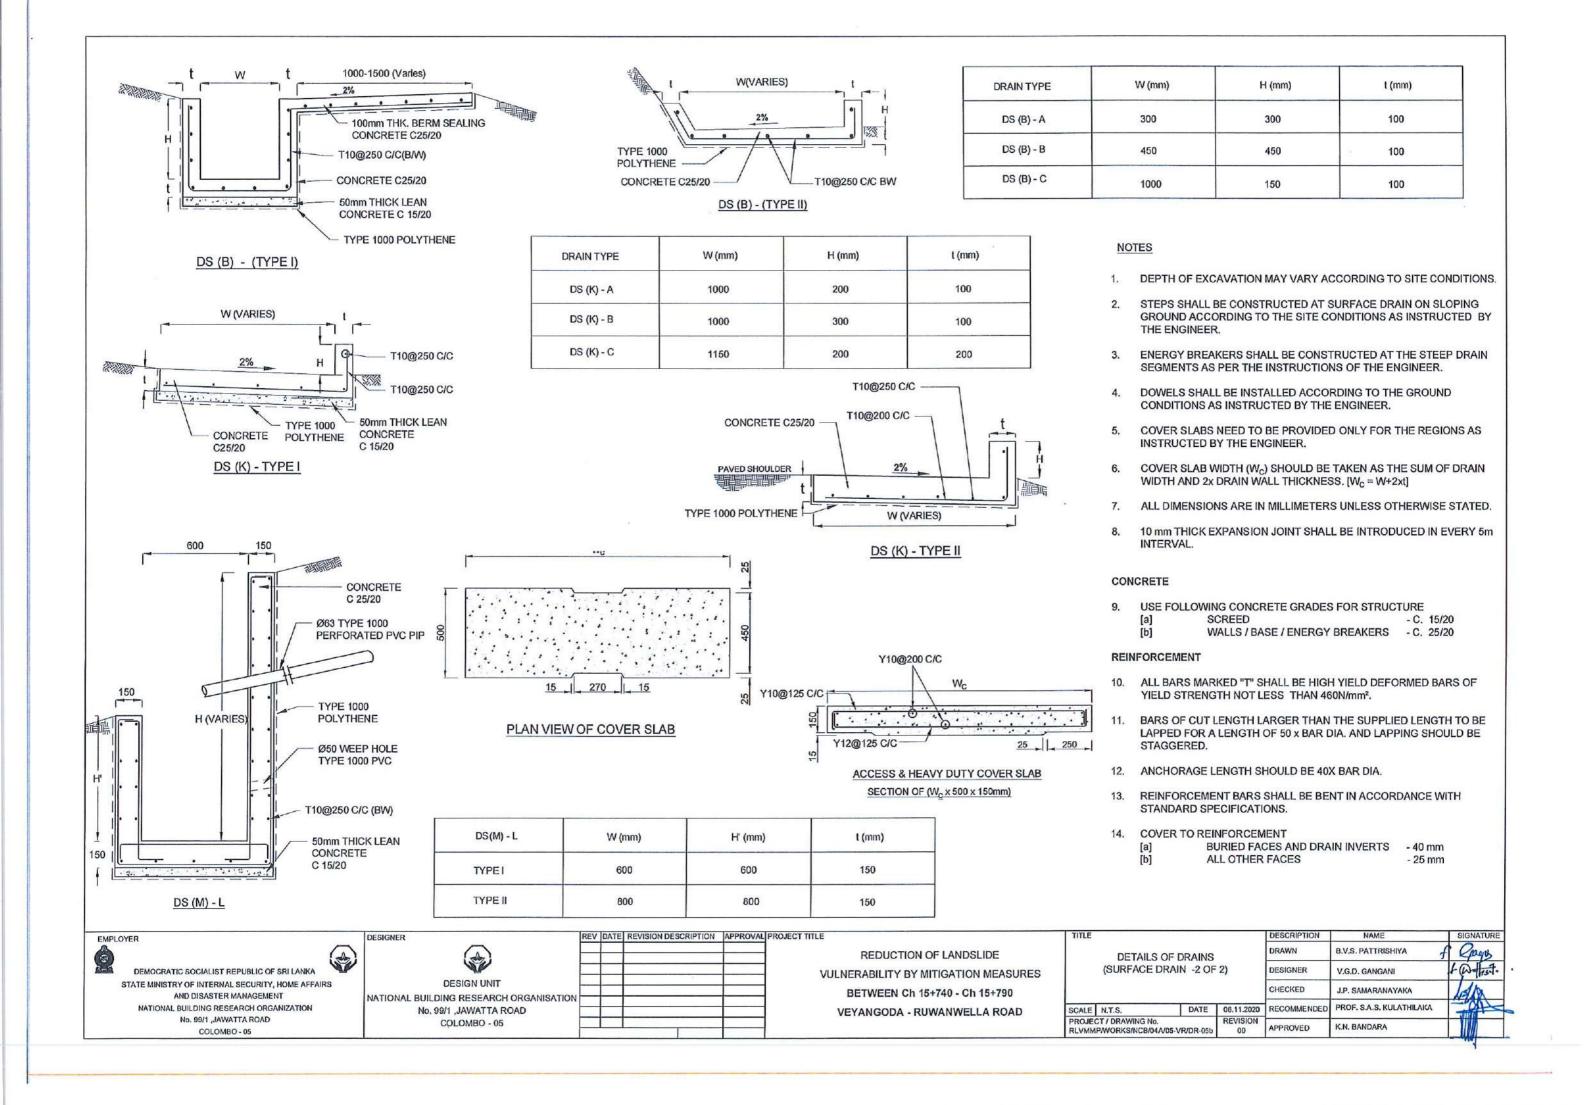

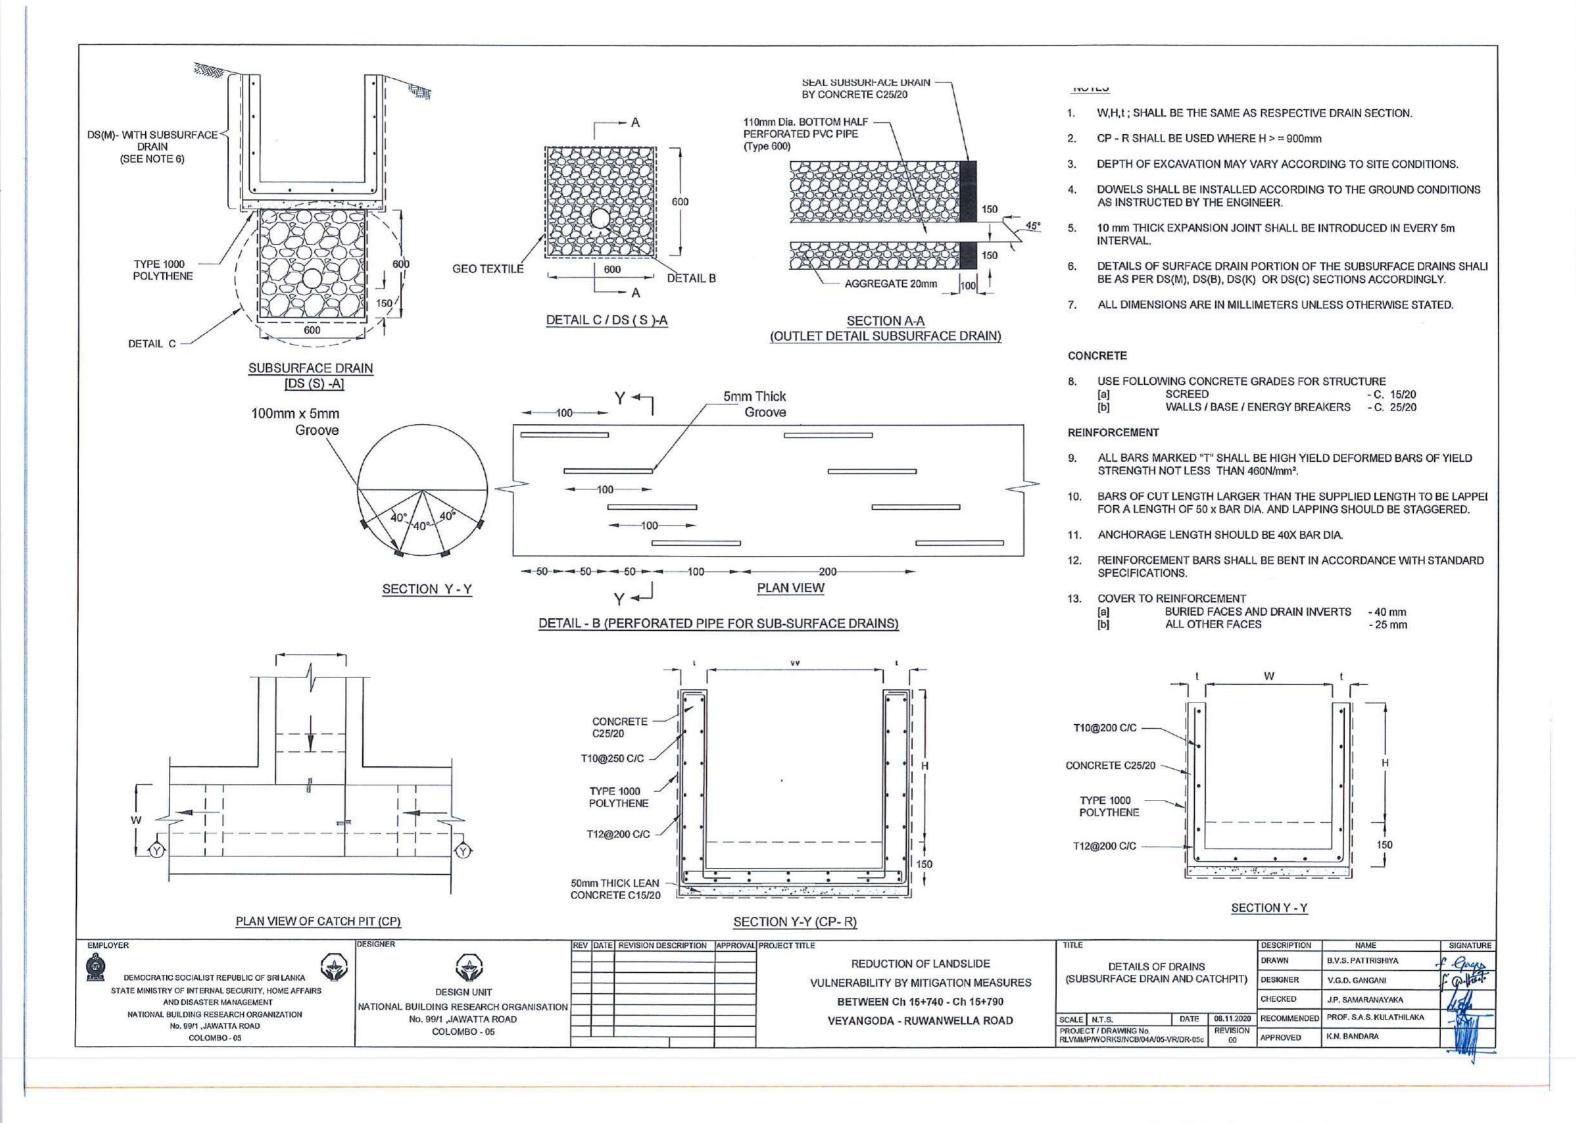

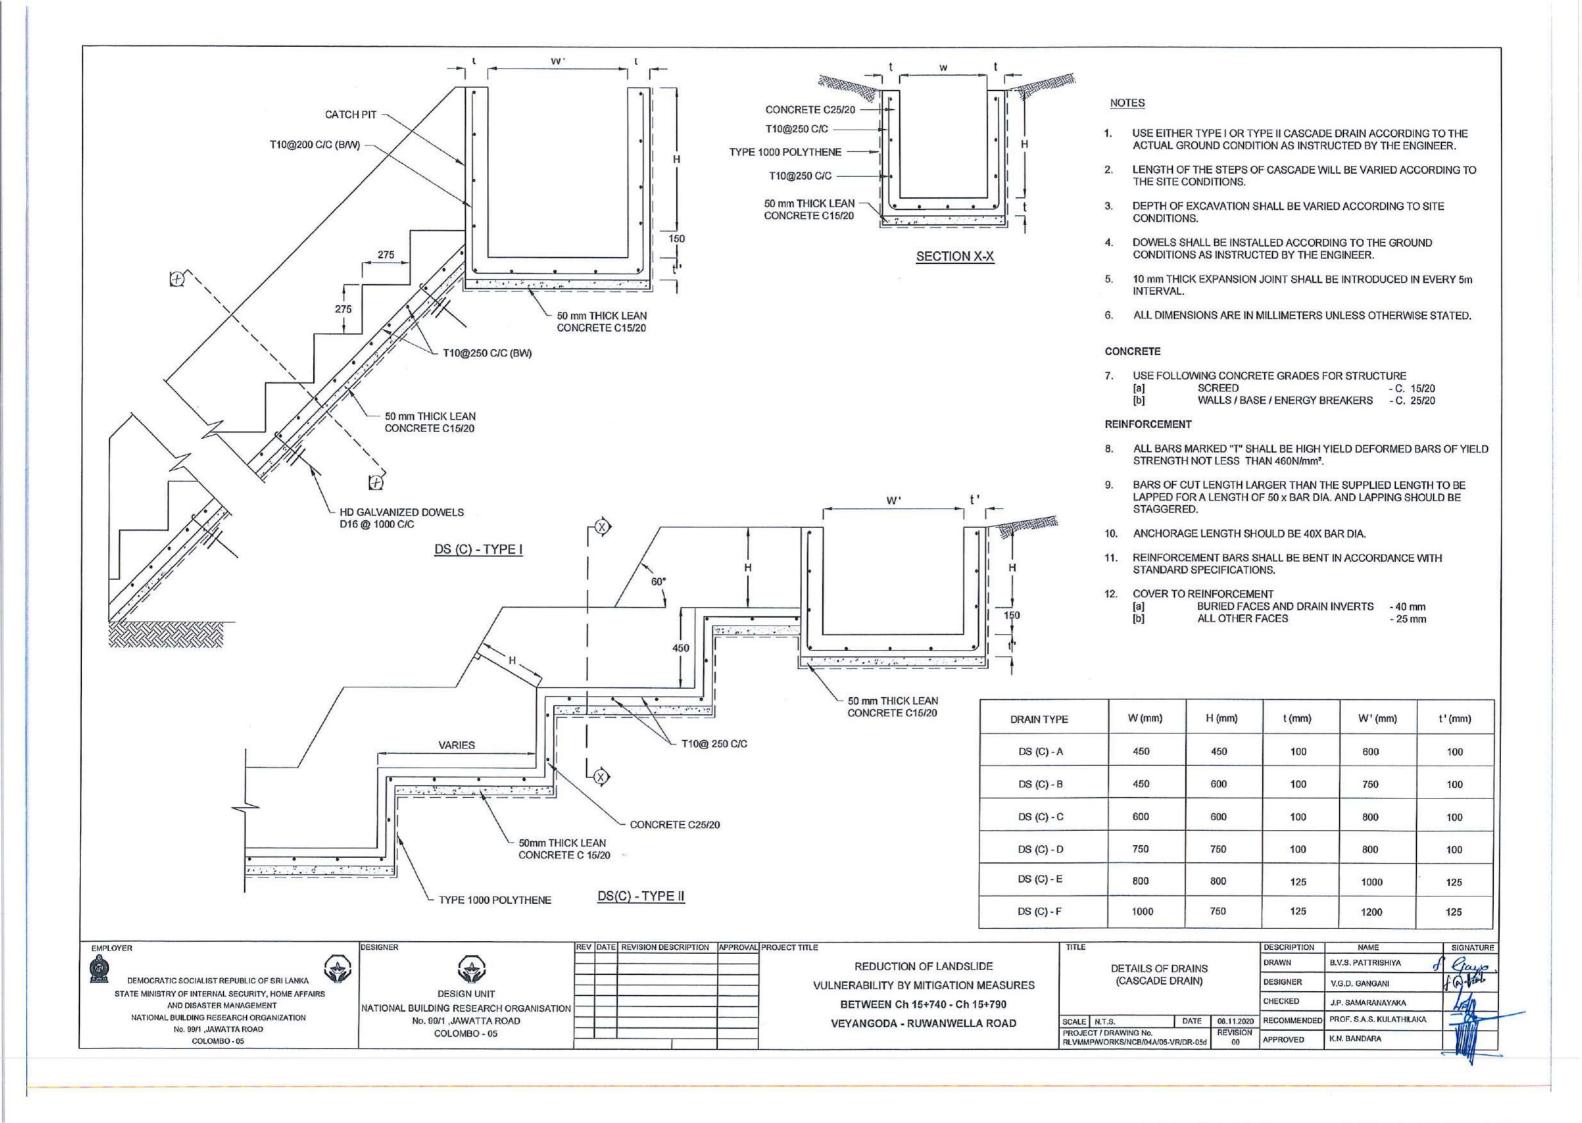

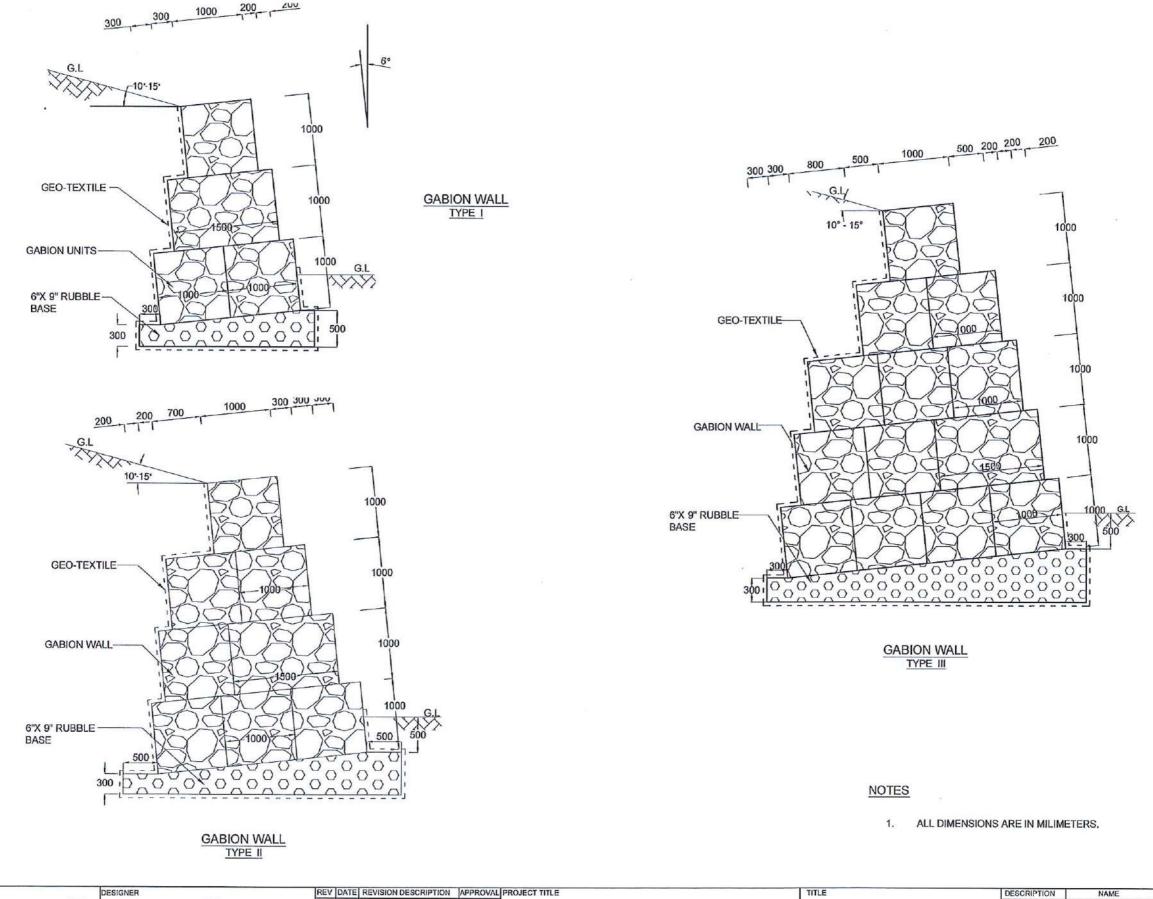

EMPLOYER

DEMOCRATIC SOCIALIST REPUBLIC OF SRI LANKA STATE MINISTRY OF INTERNAL SECURITY, HOME AFFAIRS AND DISASTER MANAGEMENT NATIONAL BUILDING RESEARCH ORGANIZATION No. 99/1 ,JAWATTA ROAD COLOMBO - 05

DESIGNER

NATIONAL BUILDING RESEARCH ORGANIZATION No. 99/1 ,JAWATTA ROAD COLOMBO - 05

REDUCTION OF LANDSLIDE **VULNERABILITY BY MITIGATION MEASURES** BETWEEN Ch 15+740 - Ch 15+790 VEYANGODA - RUWANWELLA ROAD


DETAILS OF GABION WALL


PROJECT / DRAWING No. RLVMMP/WORKS/NCB/04A/05-VR/DR-06

REVISION

SCALE N.T.S.

DESCRIPTION B.V.S. PATTRISHIYA DESIGNER V.G.D. GANGANI CHECKED J.P. SAMARANAYAKA PROF. S.A.S. KULATHILAKA RECOMMENDED DATE 06.11.2020 K.N. BANDARA **APPROVED**

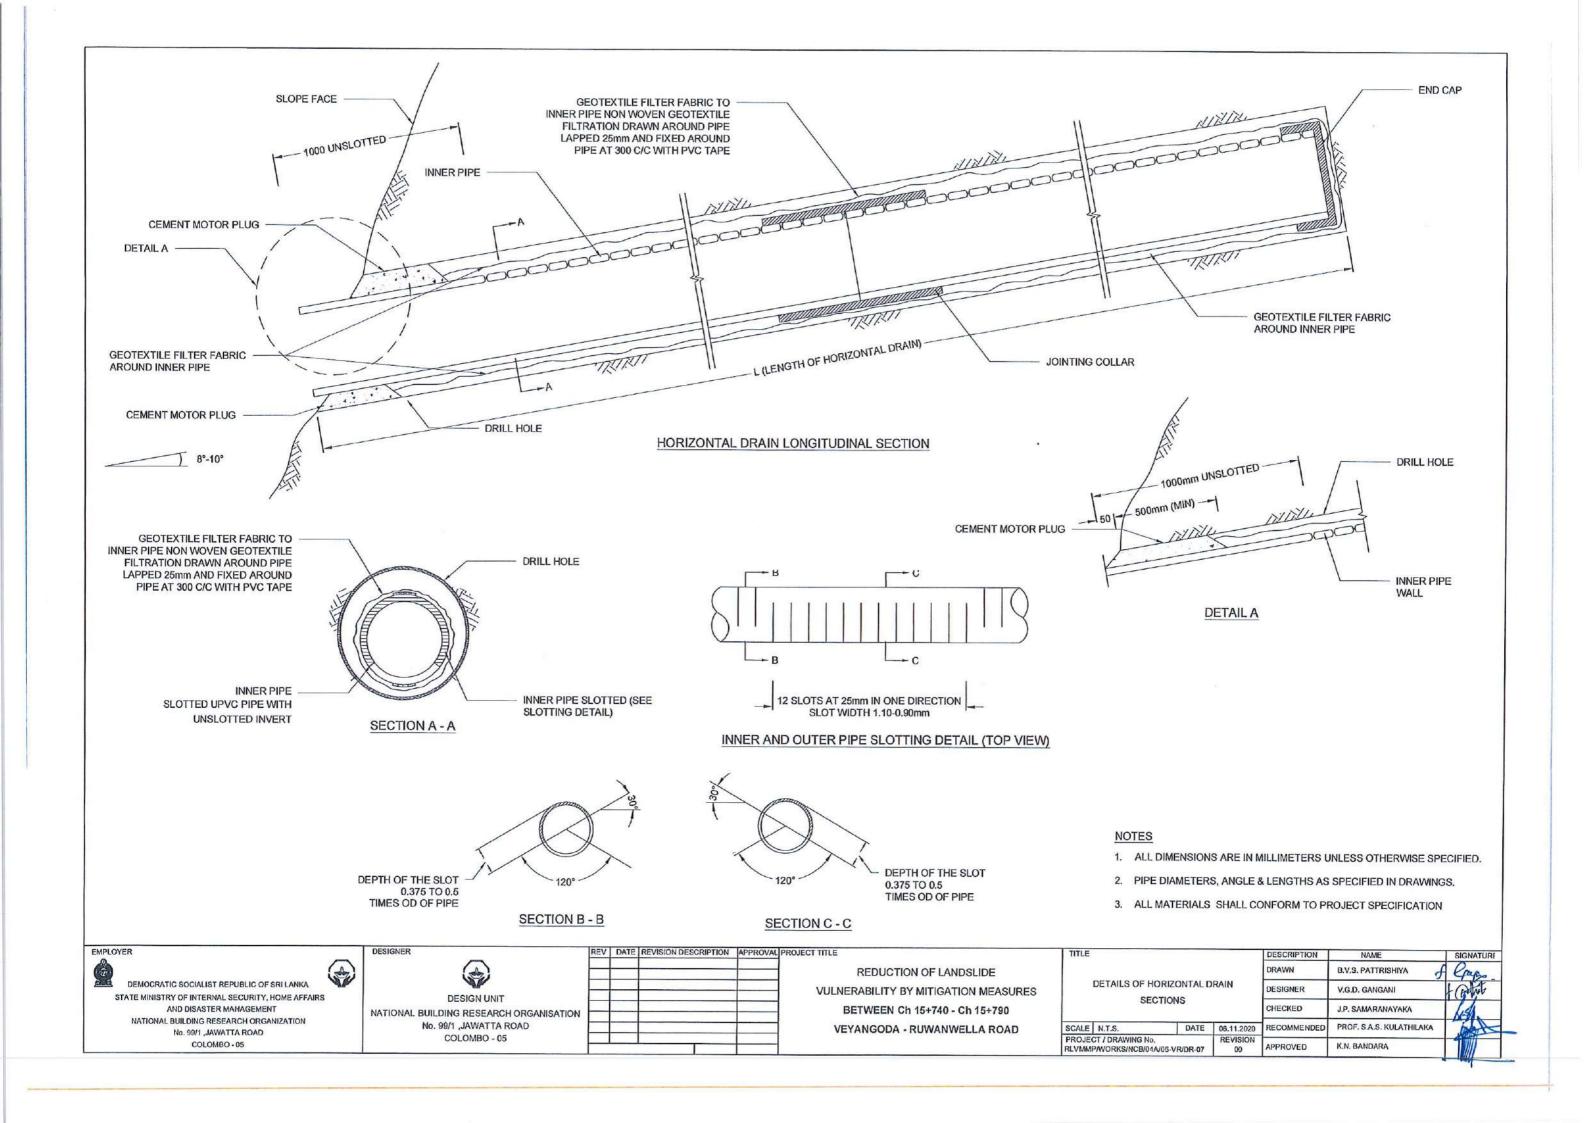

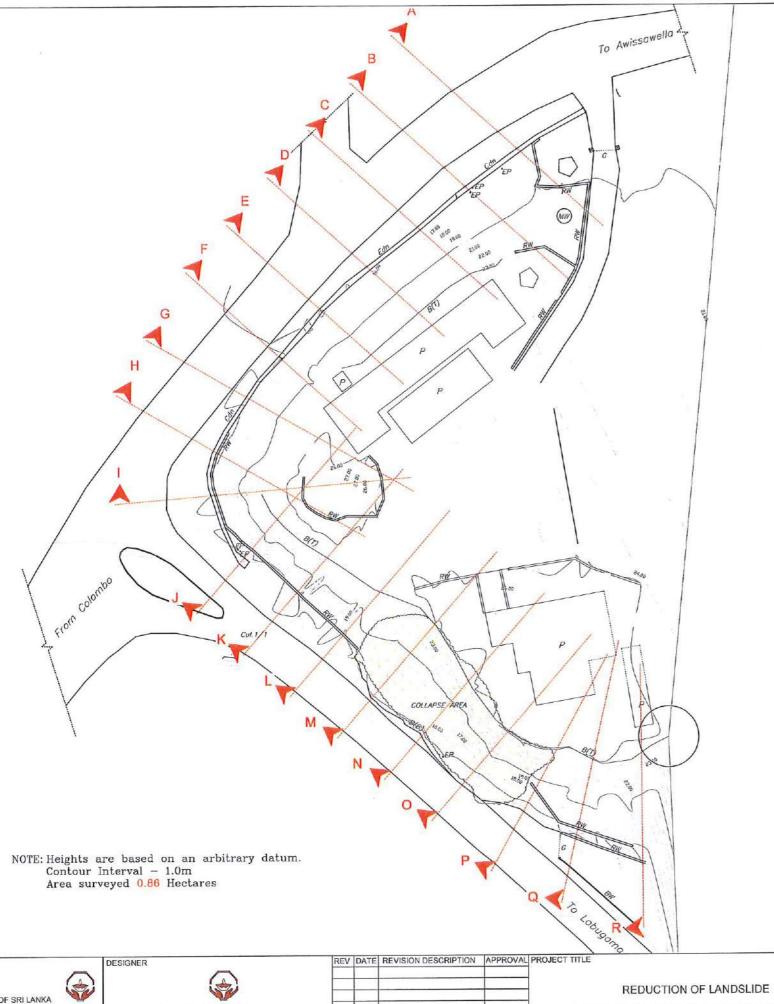

LEVEL PLAN NO: 2017/L/Colombo/LRRMD-34

REFERENCE

B(T) – Top of Bank

B(B) - Bottom of Bank

P - Permanent building

Cdn - Concrete Drain

EP - Electricity Pole

Edn - Earth Drain

MW- Masonry Well

RW - Retaining Wall

BW - Boundary Wall

G- Gate

CUL. - Culvert

EMPLOYER

DEMOCRATIC SOCIALIST REPUBLIC OF SRI LANKA STATE MINISTRY OF INTERNAL SECURITY, HOME AFFAIRS AND DISASTER MANAGEMENT NATIONAL BUILDING RESEARCH ORGANISATION No. 99/1 ,JAWATTA ROAD

COLOMBO - 05


DESIGN UNIT NATIONAL BUILDING RESEARCH ORGANISATION No. 99/1 ,JAWATTA ROAD


COLOMBO - 05

| _ | - | |
|--------|---|--|
| _ | _ | |
| | | |
| | | |
| | | |
| \neg | | |
| \neg | | |
| | _ | |

VULNERABILITY BY MITIGATION MEASURES KALUAGGALA JUNCTION


| TITLE | | | | DESCRIPTION | NAME | SIGNATURE |
|-------|--|-----------|----------------|-------------|---------------------|-----------|
| | | | | SURVEYED | KAMAL DESHAPRIYA | |
| | CONTOUR | SURVEY PL | AN | CHECKED | S.O.A.D.M. LAKRUWAN | |
| | | | w | | | |
| SCALE | N.T.S | DATE | 12.11.2020 | | | |
| | PROJECT / DRAWING No. RLVMMP/WORKS/NCB/04A/12-KA/DR-1 | | REVISION 00 | | | |

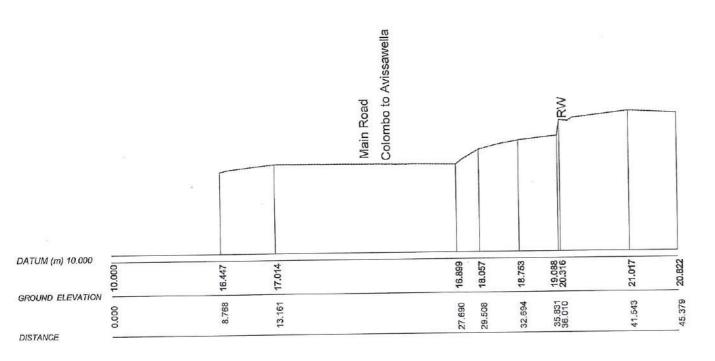


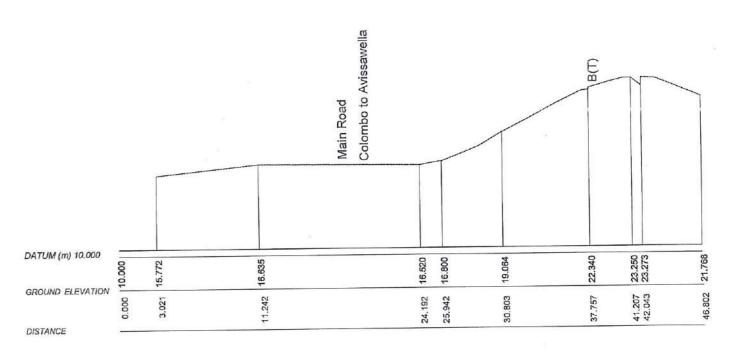

SECTION-A

SECTION-B

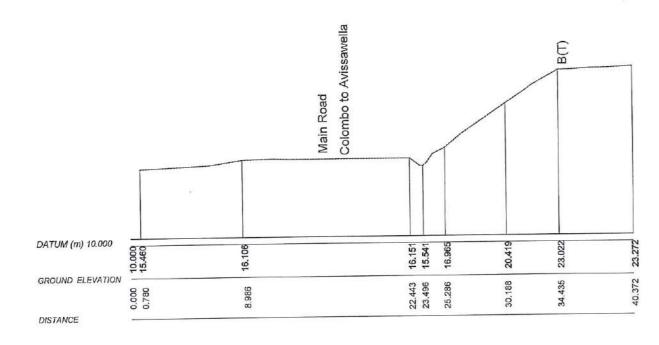

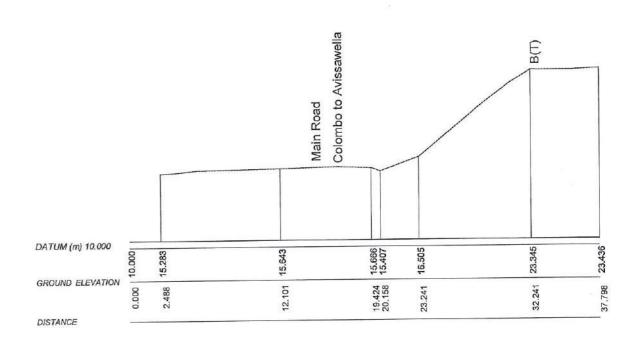

SECTION-C

SECTION-D


| EMPLO | DYER |
|------------|---|
| '∰ >= 5 | DEMOCRATIC SOCIALIST REPUBLIC OF SRI LANKA |
| | STATE MINISTRY OF INTERNAL SECURITY, HOME AFFAIRS |
| | AND DISASTER MANAGEMENT |
| | NATIONAL BUILDING RESEARCH ORGANISATION |
| | No. 99/1 ,JAWATTA ROAD |

COLOMBO - 05


| DESIGNER | REV | DATE | REVISION DESCRIPTION | APPROVAL | PROJECT TITLE |
|---|-----|------|----------------------|----------|---------------|
| | | | | | |
| | | | | | |
| DESIGN UNIT | - | - | | + | VUL |
| NATIONAL BUILDING RESEARCH ORGANISATION | | | | | |
| No. 99/1 ,JAWATTA ROAD | | | | | |
| COLOMBO - 05 | - | | | | |

| REDUCT | TION OF LANDSLIDE |
|---------------|------------------------|
| VULNERABILITY | BY MITIGATION MEASURES |
| KALUA | AGGALA JUNCTION |


| TITLE | | | | DESCRIPTION | NAME | SIGNATURE |
|------------------------|------------------|--------------|----------------|-------------|---------------------|-----------|
| | | | | SURVEYED | KAMAL DESHAPRIYA | |
| CONTOUR CROSS SECTIONS | | | | CHECKED | S.O.A.D.M. LAKRUWAN | |
| | | | | | | 1 |
| SCALE | 1:300 | DATE | 12.11.2020 | | | |
| | CT / DRAWING No. | V12-KA/DR-2a | REVISION 00 | | | |

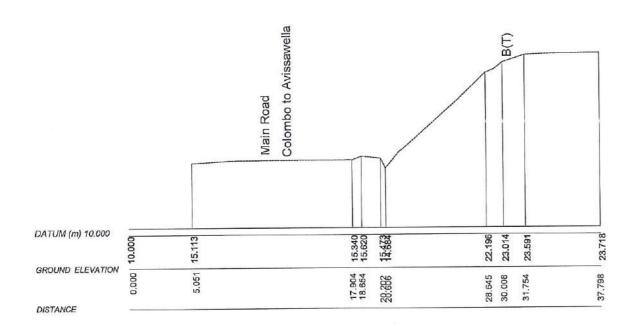


SECTION-E

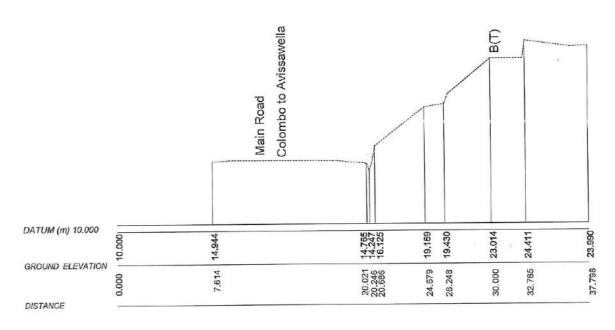

SECTION-F

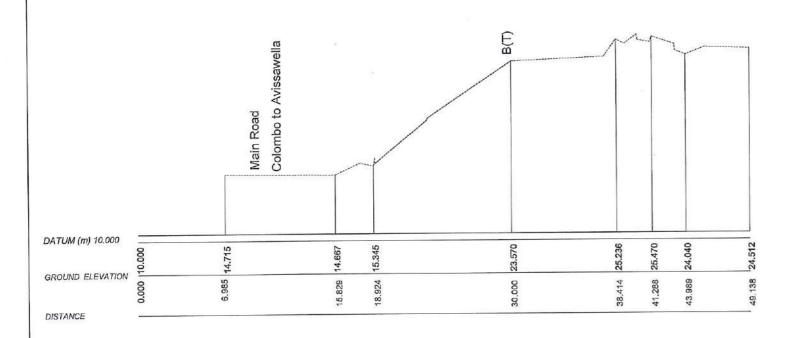

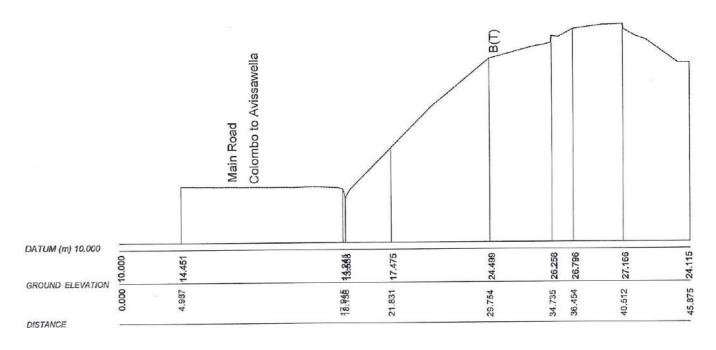

SECTION-H

DEMOCRATIC SOCIALIST REPUBLIC OF SRI LANKA
STATE MINISTRY OF INTERNAL SECURITY, HOME AFFAIRS
AND DISASTER MANAGEMENT
NATIONAL BUILDING RESEARCH ORGANISATION
No. 99/1, JAWATTA ROAD

COLOMBO - 05

DESIGNER

DESIGN UNIT

NATIONAL BUILDING RESEARCH ORGANISATION

No. 99/1 ,JAWATTA ROAD

COLOMBO - 05

SECTION-G


REV DATE REVISION DESCRIPTION APPROVAL PROJECT TITLE

REDUCTION OF LANDSLIDE


VULNERABILITY BY MITIGATION MEASURES


KALUAGGALA JUNCTION

| TITLE | | | DESCRIPTION | NAME | SIGNATURE |
|--|------|----------------|-------------|---------------------|-----------|
| | | | SURVEYED | KAMAL DESHAPRIYA . | |
| CONTOUR CROSS SECTIONS | | | CHECKED | S.O.A.D.M. LAKRUWAN | |
| | | | | | - |
| SCALE 1:300 | DATE | 12.11.2020 | | | |
| PROJECT / DRAWING No. RLVMMP/WORKS/NCB/04. | | REVISION 00 | | | |

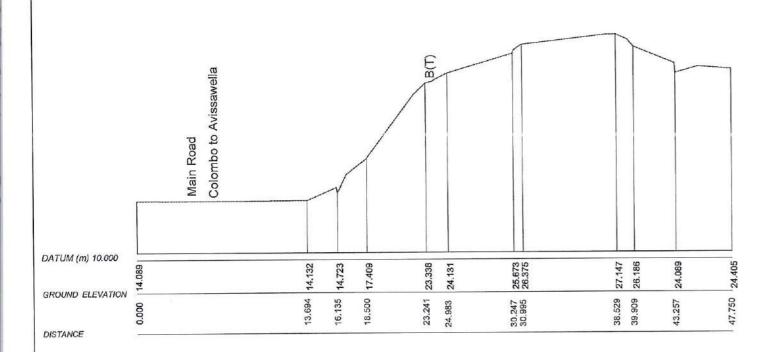

SECTION-I

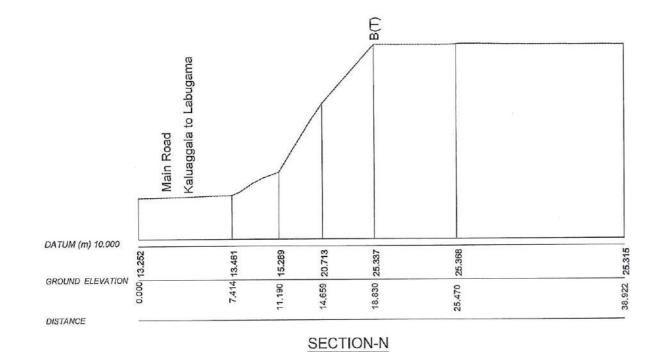

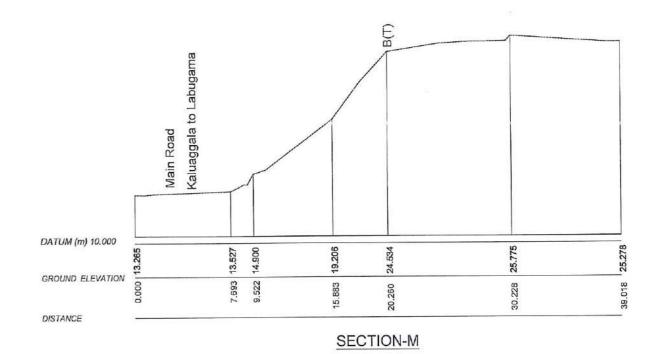



DEMOCRATIC SOCIALIST REPUBLIC OF SRI LANKA
STATE MINISTRY OF INTERNAL SECURITY, HOME AFFAIRS
AND DISASTER MANAGEMENT
NATIONAL BUILDING RESEARCH ORGANISATION
No. 99/1 ,JAWATTA ROAD


COLOMBO - 05


| ESIGNER | REV |
|---|-----|
| | |
| DESIGN UNIT | |
| NATIONAL BUILDING RESEARCH ORGANISATION | _ |
| No. 99/1 ,JAWATTA ROAD | |
| COLOMBO - 05 | |

| REDUCT | TION OF LANDSLIDE |
|---------------|------------------------|
| VULNERABILITY | BY MITIGATION MEASURES |
| KALUA | AGGALA JUNCTION |

DATE REVISION DESCRIPTION APPROVAL PROJECT TITLE

| TITLE | | | DESCRIPTION | NAME | SIGNATURE | |
|-------|------------------------------------|------|----------------|----------|---------------------|--|
| | | | | SURVEYED | KAMAL DESHAPRIYA | |
| | CONTOUR CROSS SECTIONS | | | CHECKED | S.O.A.D.M. LAKRUWAN | |
| | | | | | | |
| CALE | 1:300 | DATE | 12.11.2020 | | | |
| | CT / DRAWING No. P/WORKS/NCB/04 | | REVISION 00 | | | |

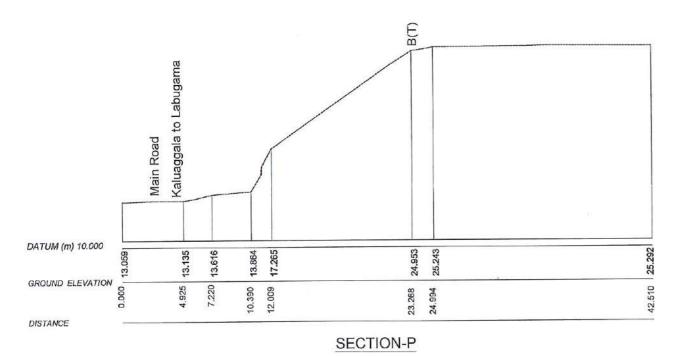

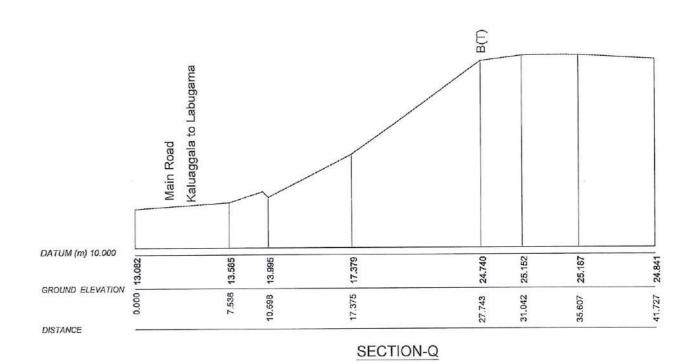

er

EMPLOYER

DEMOCRATIC SOCIALIST REPUBLIC OF SRI LANKA
STATE MINISTRY OF INTERNAL SECURITY, HOME AFFAIRS
AND DISASTER MANAGEMENT
NATIONAL BUILDING RESEARCH ORGANISATION
No. 99/1 ,JAWATTA ROAD
COLOMBO - 05

DESIGNER

D

NATIONAL BUILDIN


No. 99/1


| DESIGN UNIT | |
|-------------------------------|--|
| JILDING RESEARCH ORGANISATION | |
| lo. 99/1 ,JAWATTA ROAD | |
| COLOMBO - 05 | |

| REDUCTION OF LANDSLIDE |
|--------------------------------------|
| VULNERABILITY BY MITIGATION MEASURES |
| KALUAGGALA JUNCTION |
| |

REV DATE REVISION DESCRIPTION APPROVAL PROJECT TITLE

| TITLE | | | | DESCRIPTION | NAME | SIGNATURE |
|------------------------|-------------------------------------|------|----------------|---------------------|------------------|-----------|
| | | | | SURVEYED | KAMAL DESHAPRIYA | |
| CONTOUR CROSS SECTIONS | | | CHECKED | S.O.A.D.M. LAKRUWAN | | |
| | | DATE | 12.11.2020 | | | |
| SCALE | | | | | | |
| | CT / DRAWING No. P/WORKS/NCB/04/ | | REVISION 00 | | | |

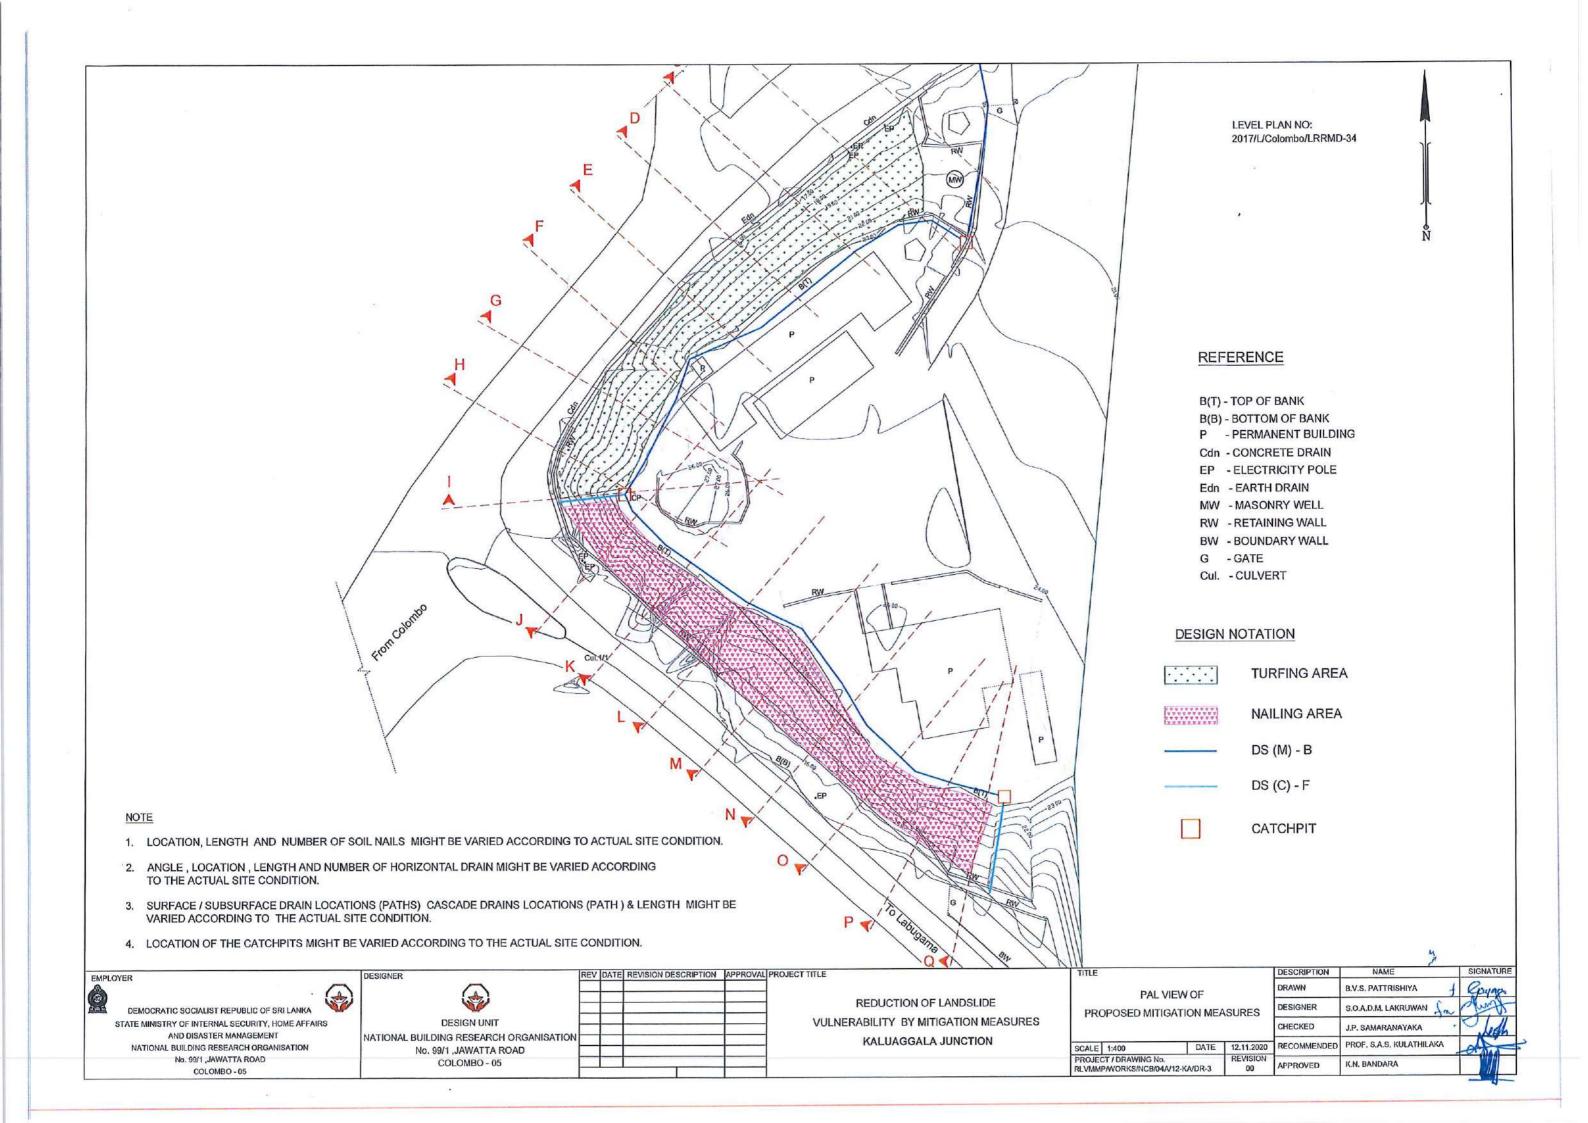


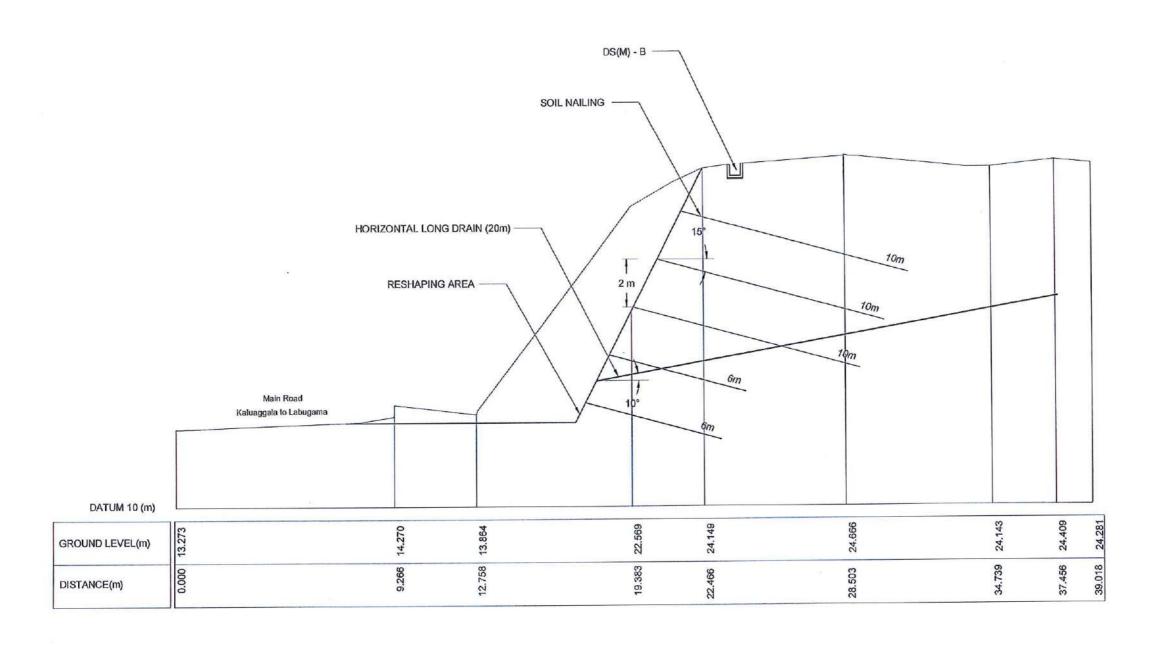


SECTION - K

NOTE:

- LOCATION, LENGTH AND NUMBER OF SOIL NAILS MIGHT BE VARIED ACCORDING TO THE SITE CONDITION ENCOUNTERED DURING CONSTRUCTION.
- ANGLE, LOCATION, LENGTH AND NUMBER OF HORIZONTAL DRAINS MIGHT BE VARIED ACCORDING TO THE SITE CONDITION ENCOUNTERED DURING CONSTRUCTION.

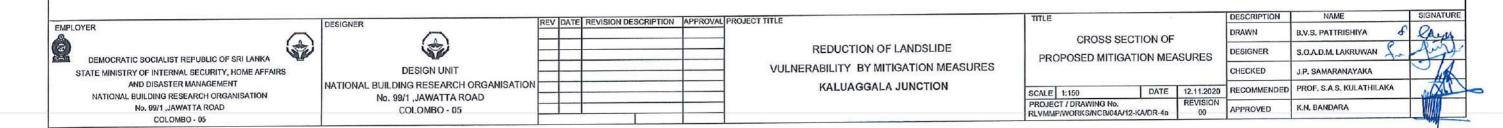


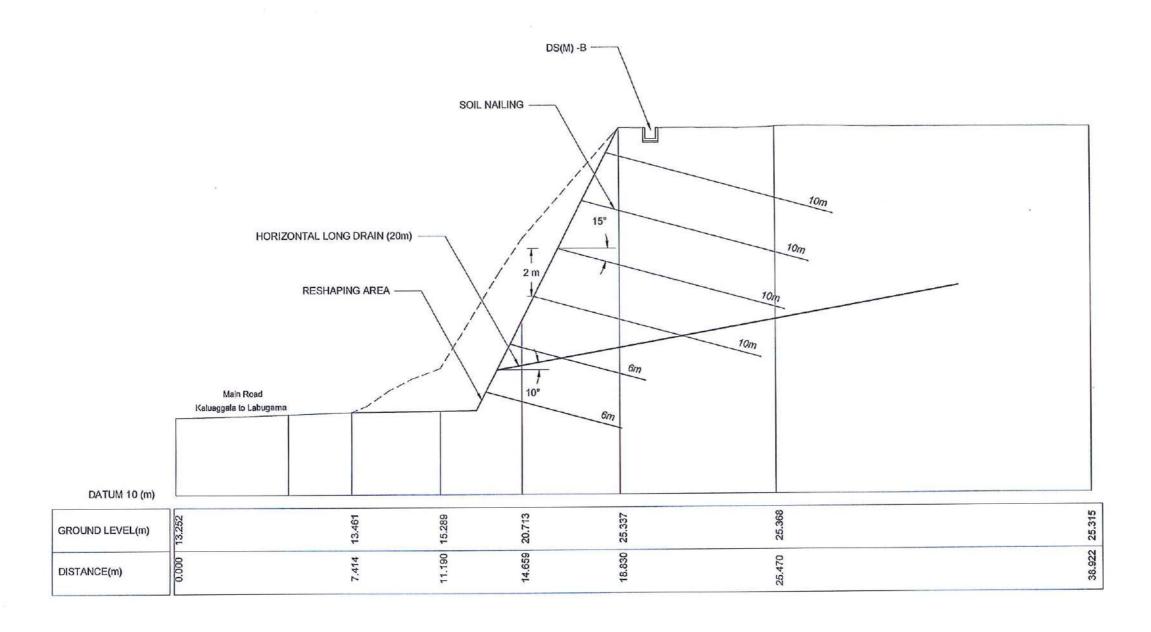


SECTION - O

NOTE:

- LOCATION, LENGTH AND NUMBER OF SOIL NAILS MIGHT BE VARIED ACCORDING TO THE SITE CONDITION ENCOUNTERED DURING CONSTRUCTION.
- ANGLE, LOCATION, LENGTH AND NUMBER OF HORIZONTAL DRAINS MIGHT BE VARIED ACCORDING TO THE SITE CONDITION ENCOUNTERED DURING CONSTRUCTION.

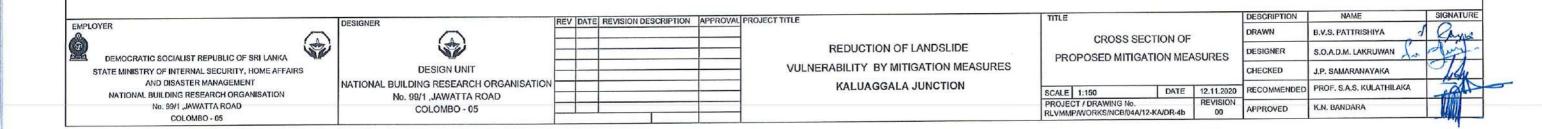

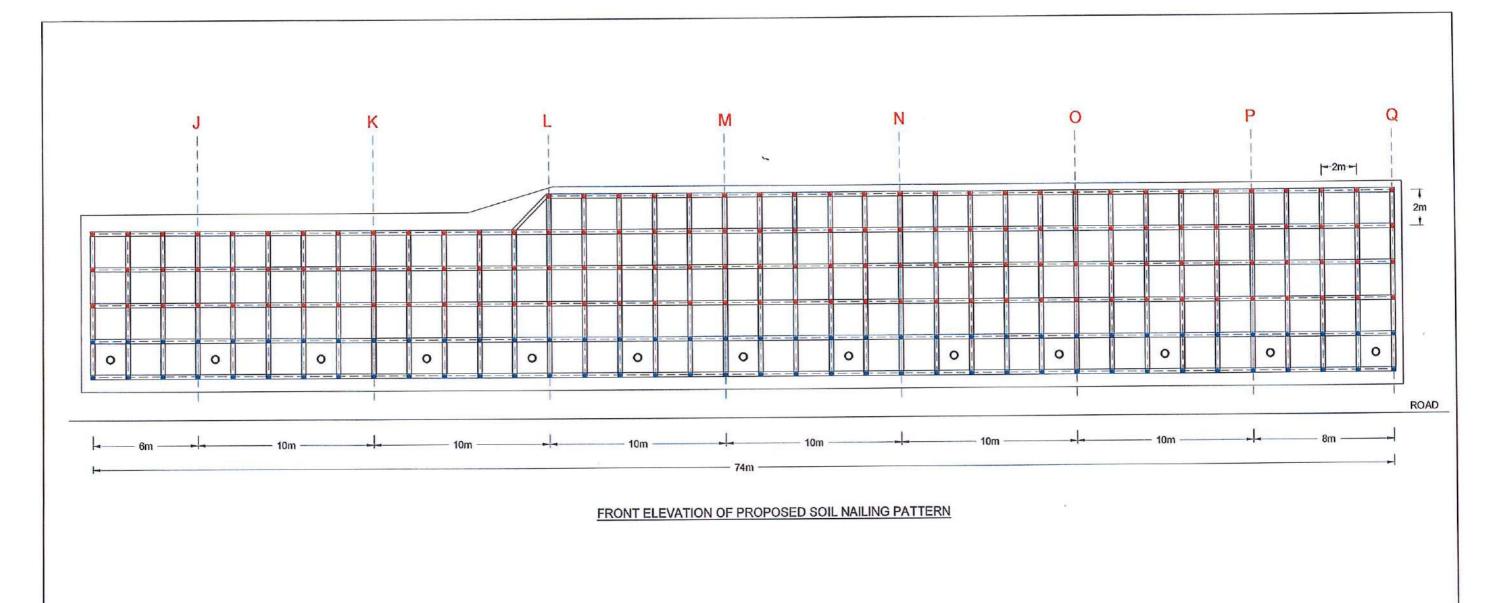

NO'S OF NAILS = 76

DESIGN NAIL LENGTH = 6m

REINFORCEMENT DIAMETER = 32mm

DIAMETER OF THE BOREHOLE = 125mm

SOIL NAILING

SOIL NAILING

DESIGN NAIL LENGTH = 10m NO'S OF NAILS = 139

REINFORCEMENT DIAMETER = 32mm

DIAMETER OF THE BOREHOLE = 125mm

HORIZONTAL LONG DRAINS


DRAIN LENGTH= 20m NO'S OF DRAINS = 13

DIAMETER = 75mm


NOTE


- LOCATION, LENGTH AND NUMBER OF SOIL NAILS MIGHT BE VARIED ACCORDING TO THE SITE CONDITION ENCOUNTERED DURING CONSTRUCTION.
- ANGLE, LOCATION, LENGTH AND NUMBER OF HORIZONTAL DRAINS MIGHT BE VARIED ACCORDING TO THE SITE CONDITION ENCOUNTERED DURING CONSTRUCTION.

DESCRIPTION REV DATE REVISION DESCRIPTION | APPROVAL PROJECT TITLE DESIGNER **EMPLOYER** B.V.S. PATTRISHIYA FRONT ELEVATION OF REDUCTION OF LANDSLIDE DESIGNER S.O.A.D.M. LAKRUWAN PROPOSED MITIGATION MEASURES DEMOCRATIC SOCIALIST REPUBLIC OF SRI LANKA VULNERABILITY BY MITIGATION MEASURES STATE MINISTRY OF INTERNAL SECURITY, HOME AFFAIRS **DESIGN UNIT** CHECKED J.P. SAMARANAYAKA AND DISASTER MANAGEMENT NATIONAL BUILDING RESEARCH ORGANISATION KALUAGGALA JUNCTION RECOMMENDED Prof. S.A.S. KULATHILAKA SCALE 1:200 DATE 12.11.2020 NATIONAL BUILDING RESEARCH ORGANISATION No. 99/1 ,JAWATTA ROAD REVISION 00 No. 99/1 ,JAWATTA ROAD COLOMBO - 05 APPROVED K.N.BANDARA RLVMMP/WORKS/NCB/04A/12-KA/DR-5 COLOMBO - 05

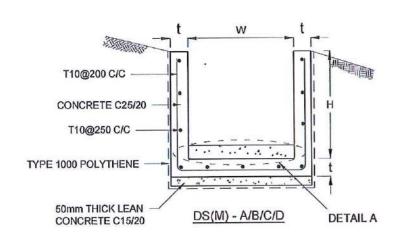

| DRAIN TYPE | W (mm) | H (mm) | t (mm) |
|---------------|--------|--------|--------|
| DS (M) - A /P | 300 | 300 | 100 |
| DS (M) - B/R | 450 | 450 | 100 |
| DS (M) - C/Q | 600 | 600 | 100 |
| DS (M) - D | 750 | 750 | 125 |
| DS (M) - E | 900 | 900 | 150 |
| DS (M) - F | 1000 | 1000 | 150 |

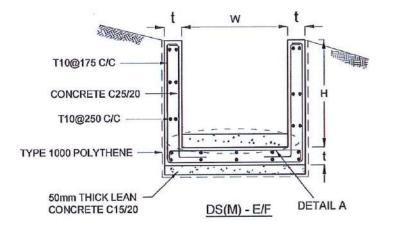

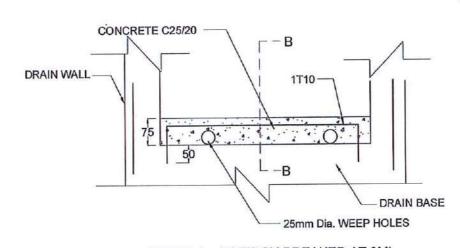

DETAIL A - (ENERGY BREAKER AT 3M)

NOTES

- DEPTH OF EXCAVATION MAY VARY ACCORDING TO SITE CONDITIONS.
- STEPS SHALL BE CONSTRUCTED AT SURFACE DRAIN ON SLOPING GROUND ACCORDING TO THE SITE CONDITIONS AS INSTRUCTED BY THE ENGINEER.
- ENERGY BREAKERS SHALL BE CONSTRUCTED AT THE STEEP DRAIN SEGMENTS AS PER THE INSTRUCTIONS OF THE ENGINEER.
- DOWELS SHALL BE INSTALLED ACCORDING TO THE GROUND CONDITIONS AS INSTRUCTED BY THE ENGINEER.
- ALL DIMENSIONS ARE IN MILLIMETERS UNLESS OTHERWISE STATED.
- 10 mm THICK EXPANSION JOINT SHALL BE INTRODUCED IN EVERY 5m INTERVAL.


CONCRETE


- USE FOLLOWING CONCRETE GRADES FOR STRUCTURE - C. 15/20

 - WALLS / BASE / ENERGY BREAKERS C. 25/20 [b]


REINFORCEMENT

- ALL BARS MARKED "T" SHALL BE HIGH YIELD DEFORMED BARS OF YIELD STRENGTH NOT LESS THAN 460N/mm².
- BARS OF CUT LENGTH LARGER THAN THE SUPPLIED LENGTH TO BE LAPPED FOR A LENGTH OF 50 x BAR DIA. AND LAPPING SHOULD BE
- ANCHORAGE LENGTH SHOULD BE 40X BAR DIA.
- REINFORCEMENT BARS SHALL BE BENT IN ACCORDANCE WITH STANDARD SPECIFICATIONS.
- COVER TO REINFORCEMENT
 - BURIED FACES AND DRAIN INVERTS - 40 mm
 - ALL OTHER FACES [b]

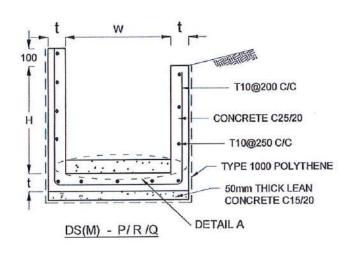

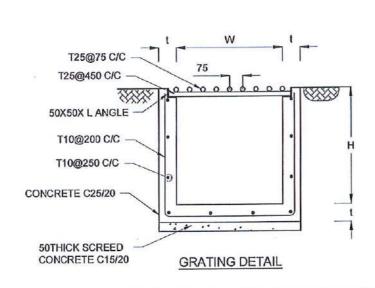

REV DATE REVISION DESCRIPTION | APPROVAL PROJECT TITLE

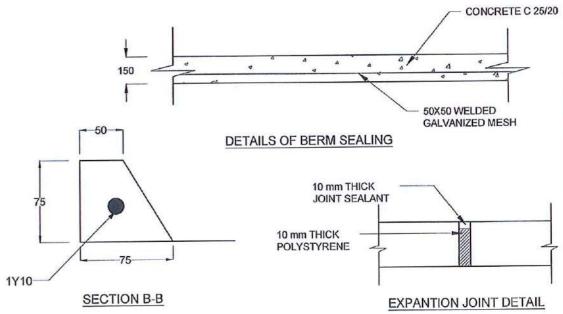

REVISION

EMPLOYER DEMOCRATIC SOCIALIST REPUBLIC OF SRI LANKA STATE MINISTRY OF INTERNAL SECURITY, HOME AFFAIRS AND DISASTER MANAGEMENT NATIONAL BUILDING RESEARCH ORGANIZATION No. 99/1 "JAWATTA ROAD

COLOMBO - 05

DESIGNER NATIONAL BUILDING RESEARCH ORGANISATION No. 99/1 ,JAWATTA ROAD COLOMBO - 05


REDUCTION OF LANDSLIDE VULNERABILITY BY MITIGATION MEASURES KALUAGGALA JUNCTION


DETAILS OF DRAINS (SURFACE DRAIN -1 OF 2)


RLVMMP/WORKS/NCB/04A/12-KA/DR-05a


PROJECT / DRAWING No.


DESCRIPTION DRAWN **B.V.S. PATTRISHIYA** PROF. S.A.S. KULATHILAKA RECOMMENDED DATE 12.11.2020 APPROVED K.N. BANDARA

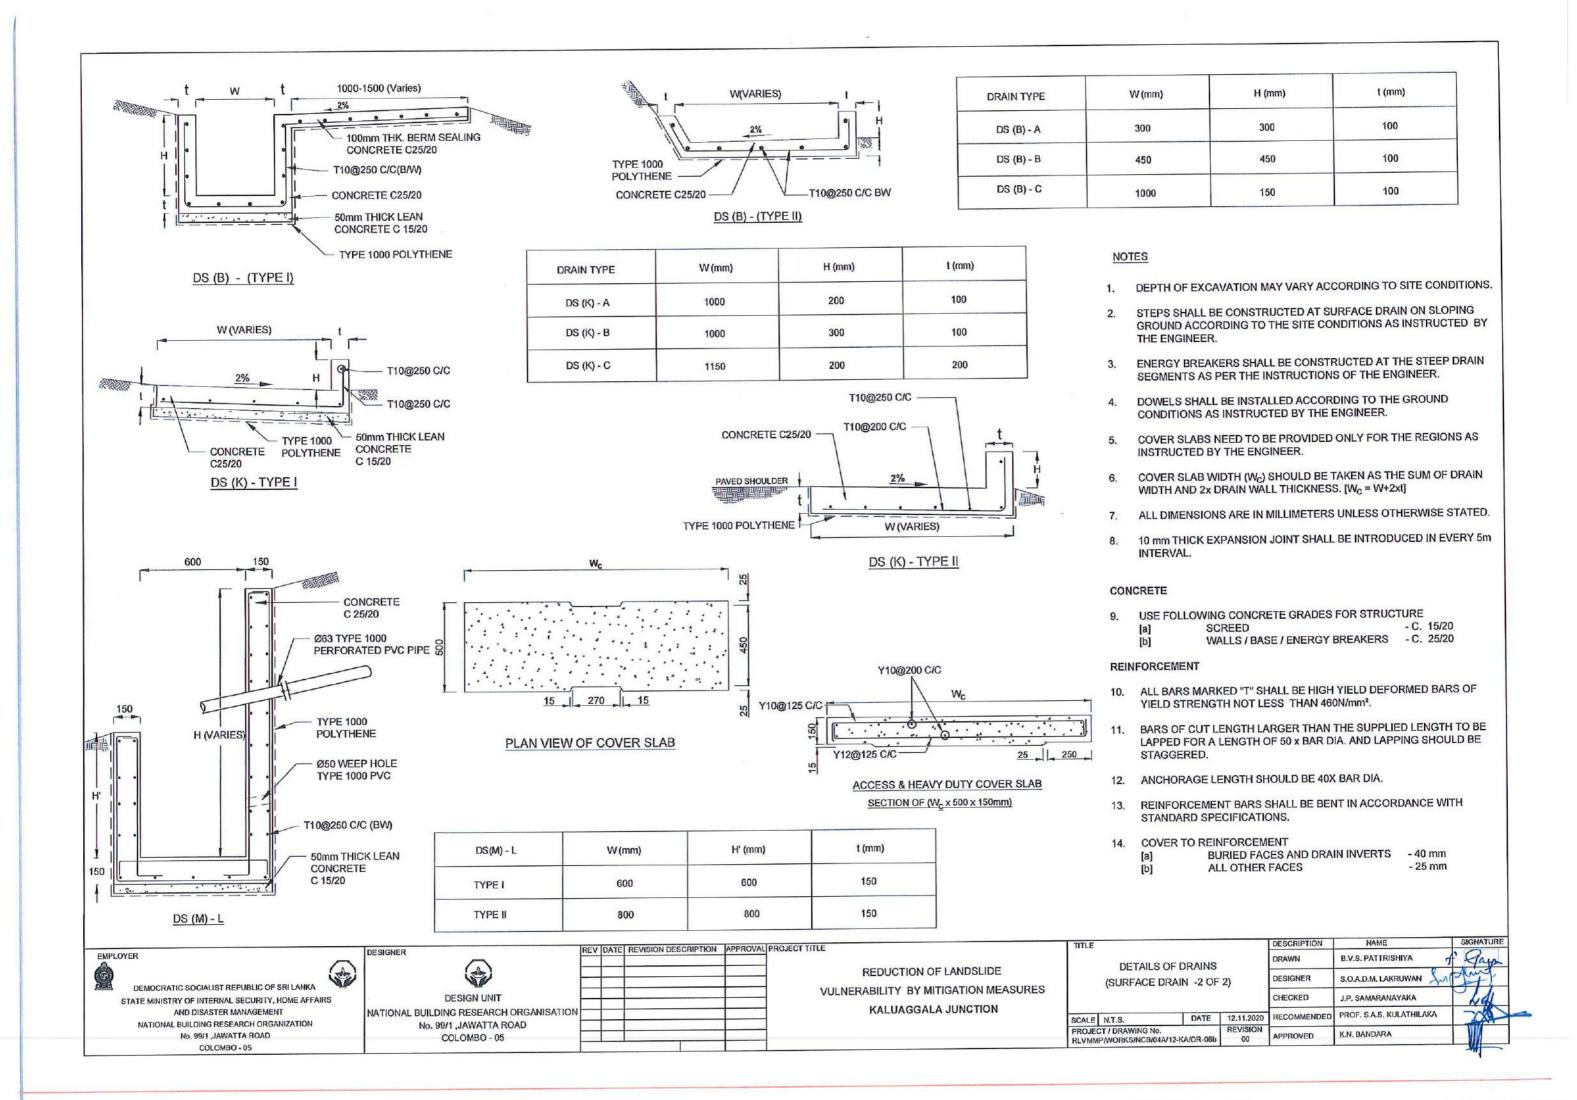


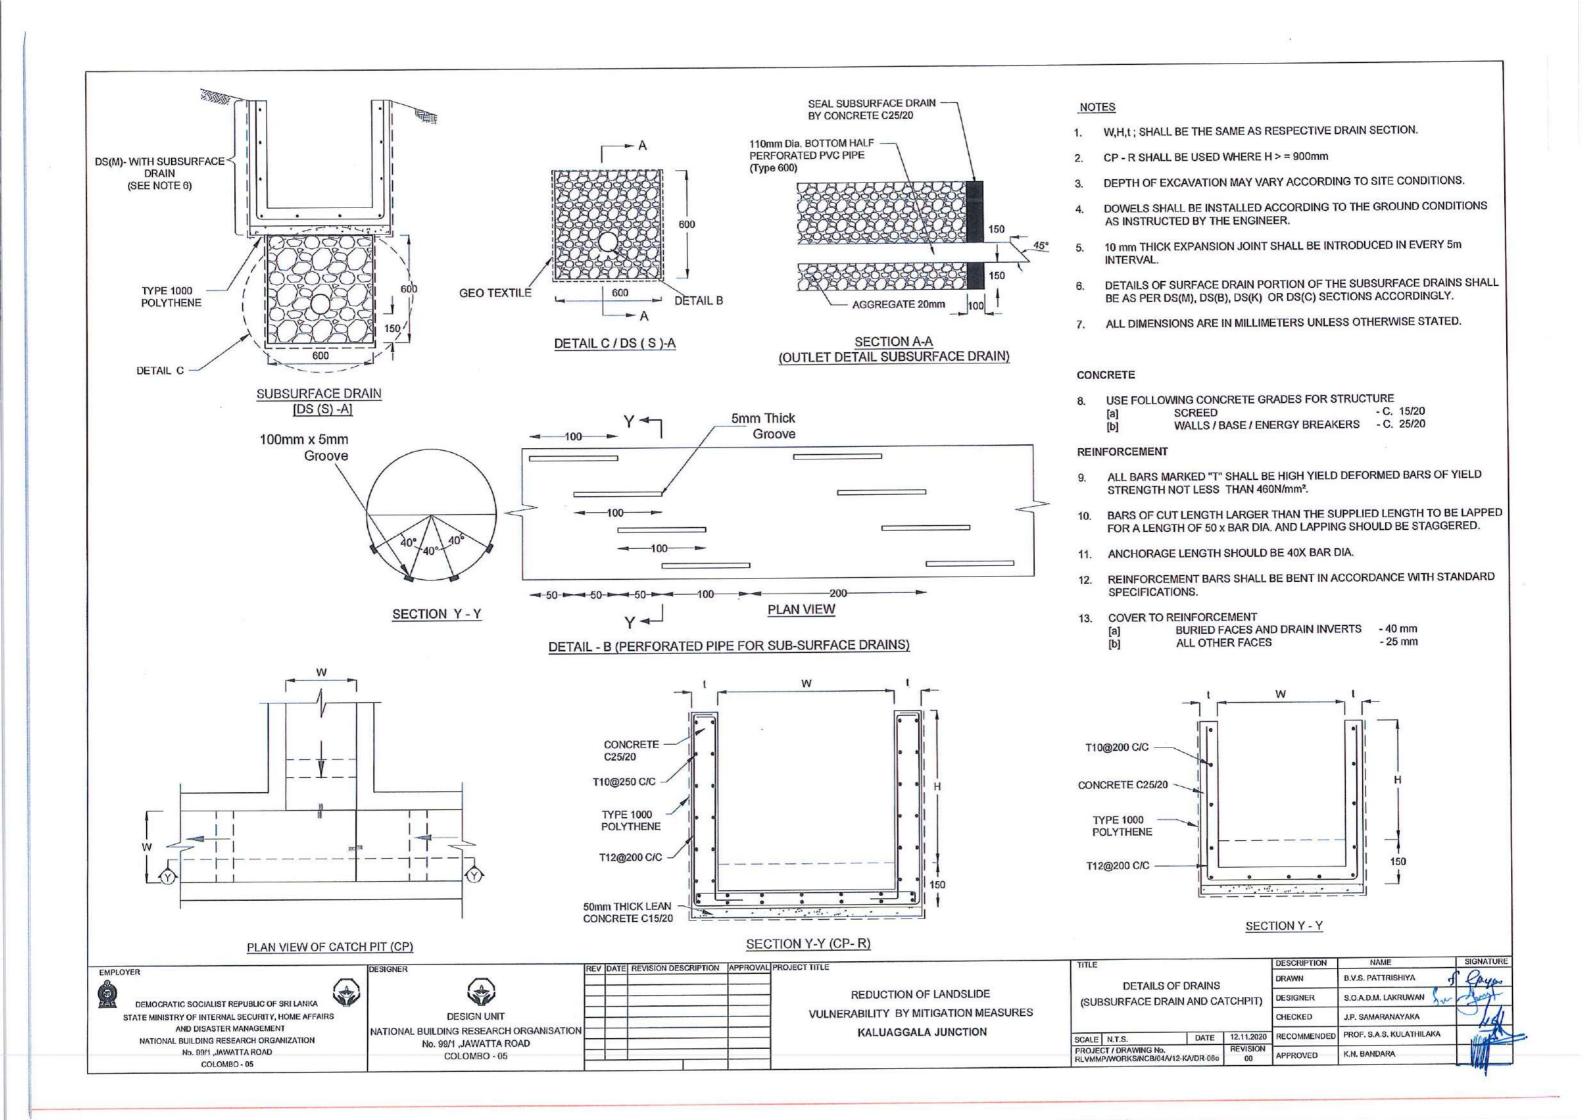


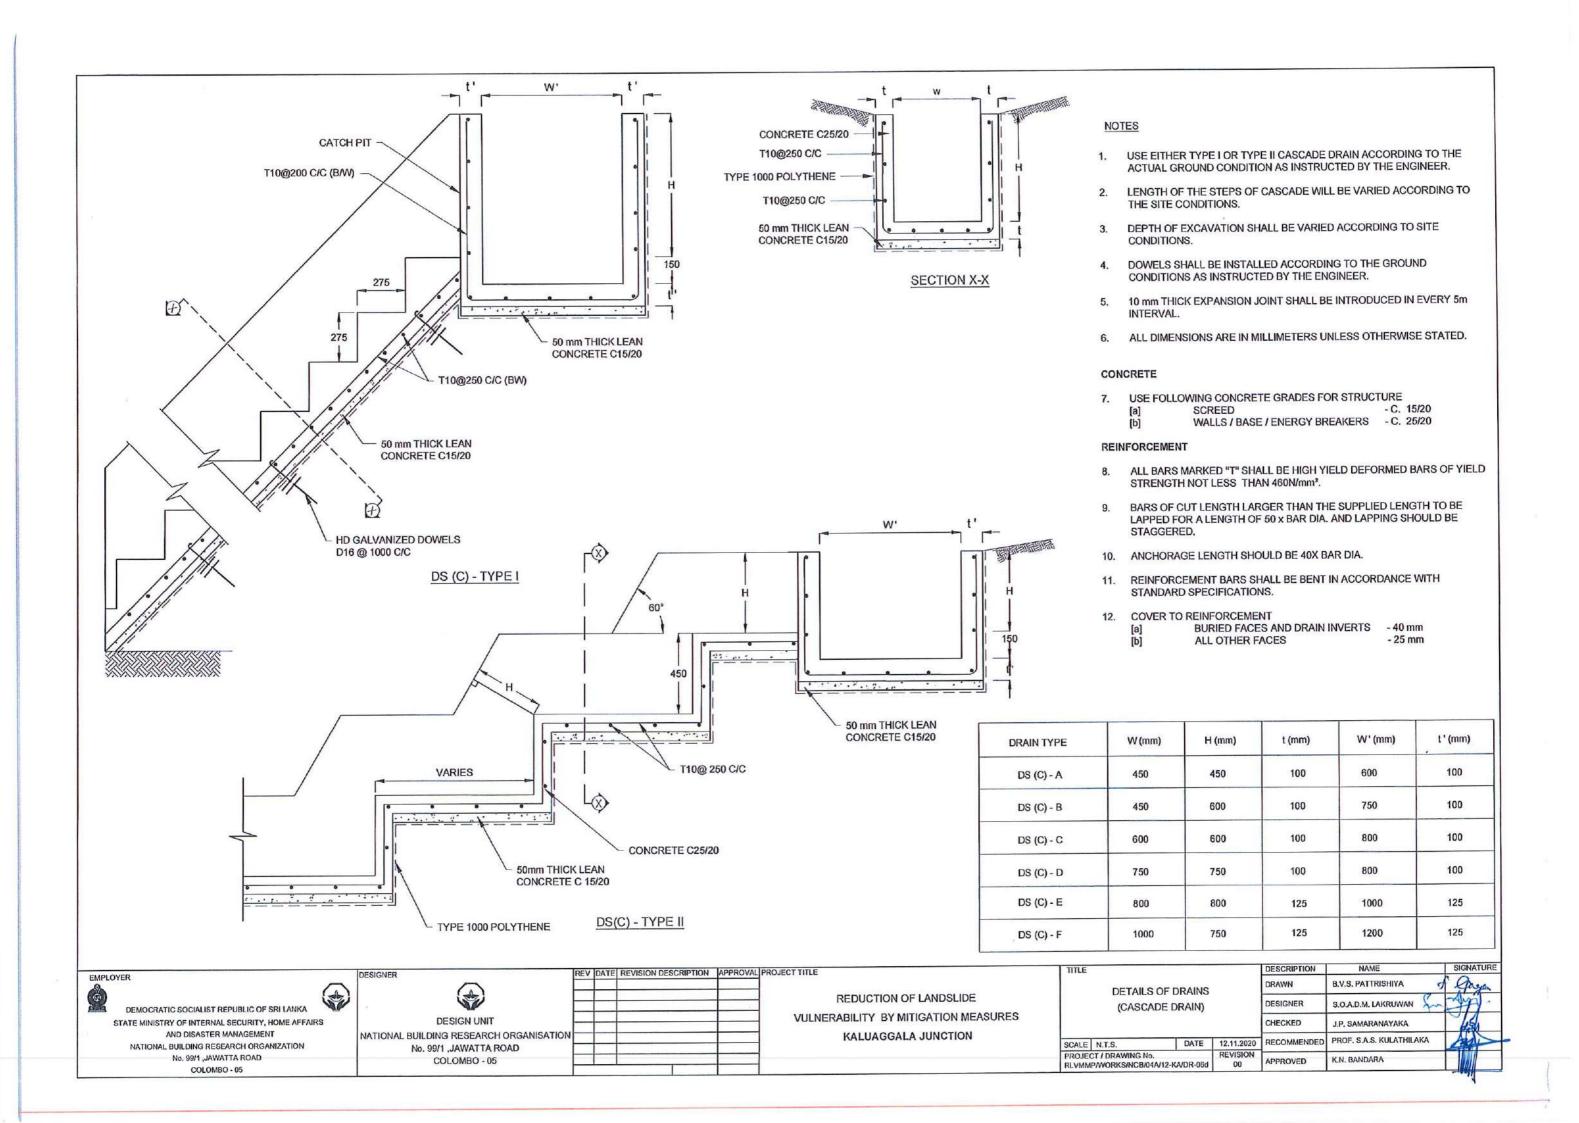


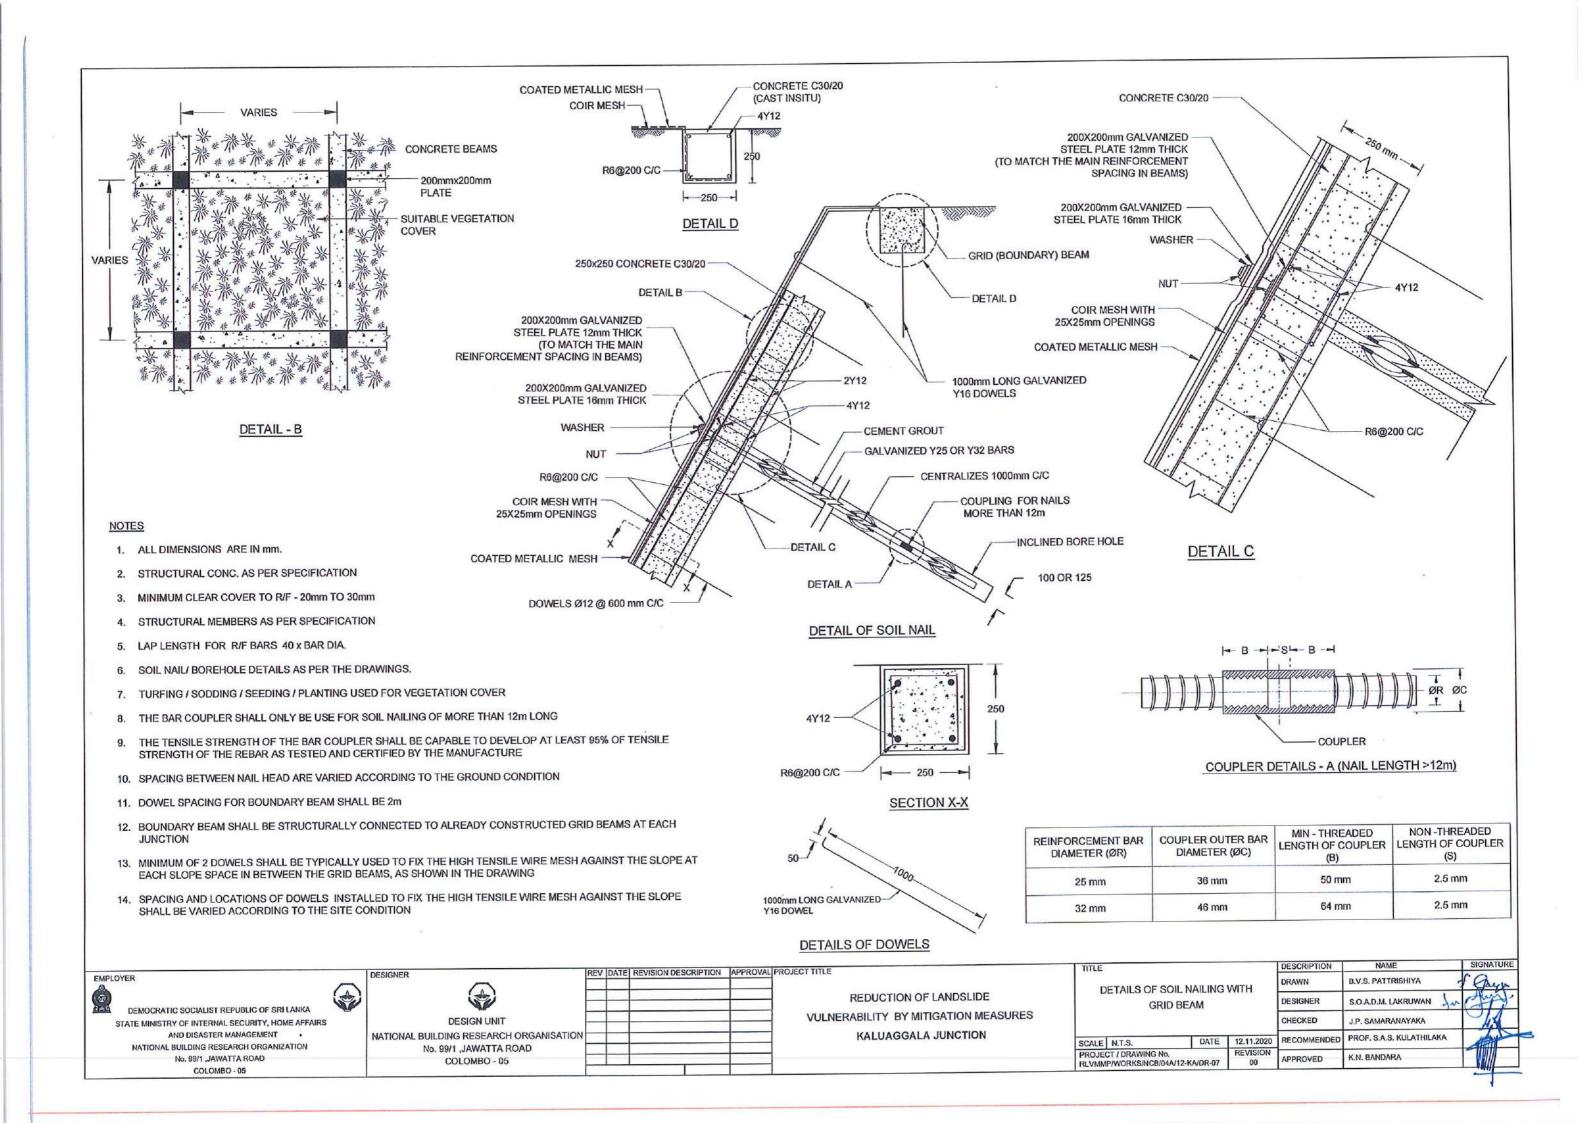


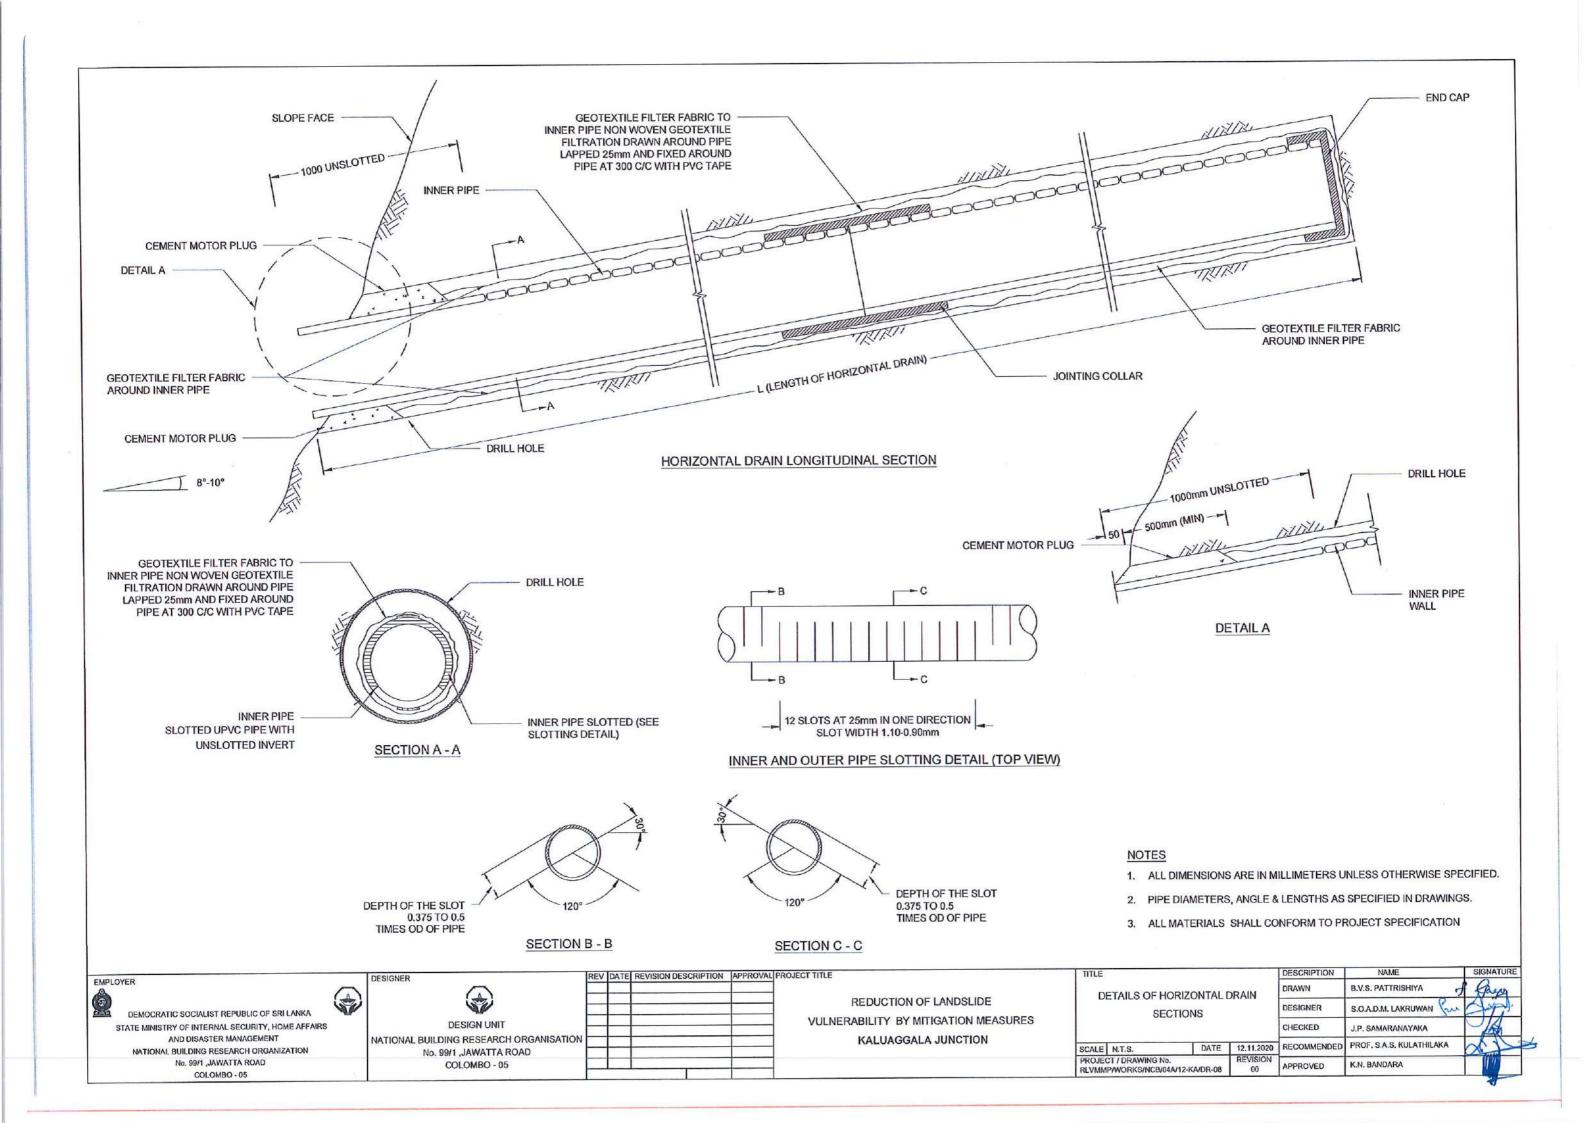

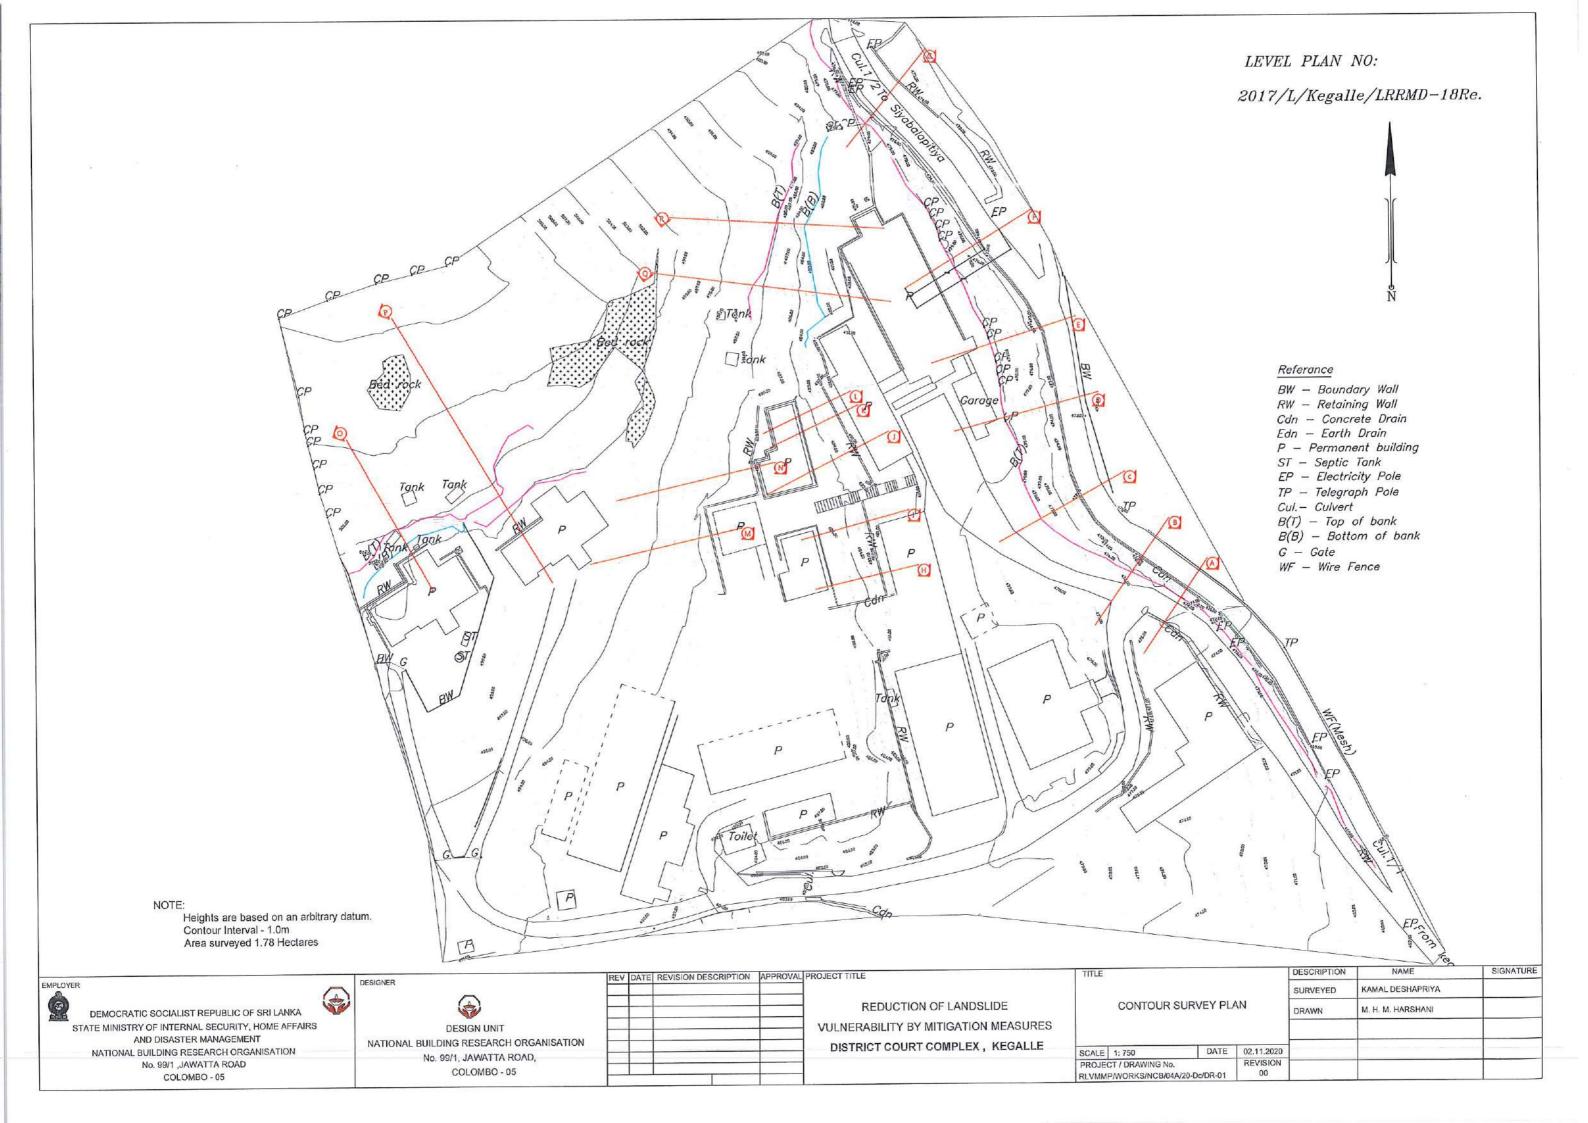


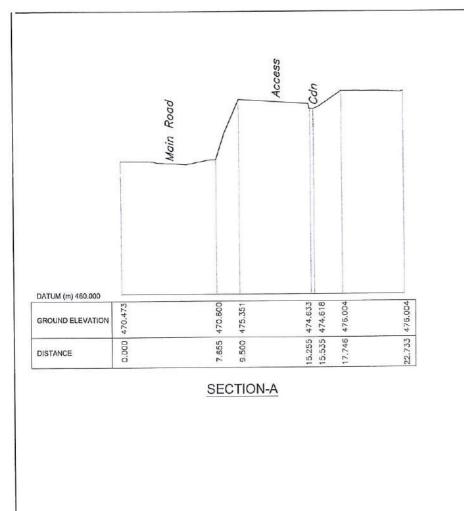


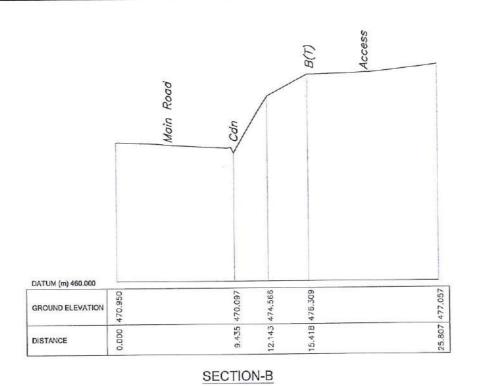


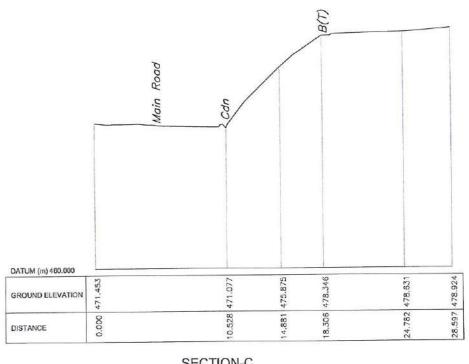

SECTION-C

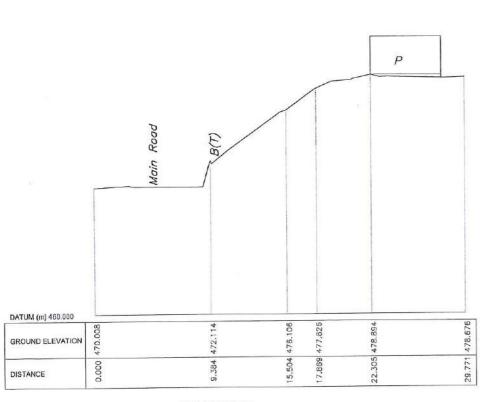

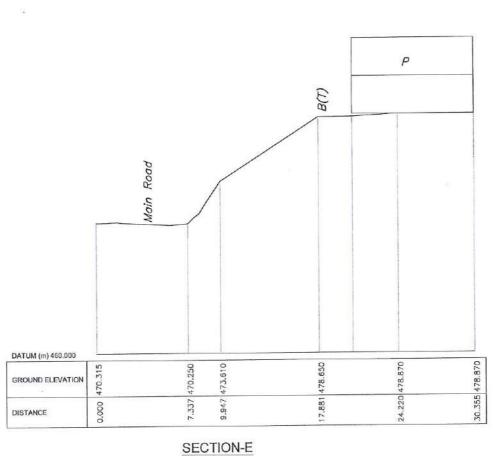

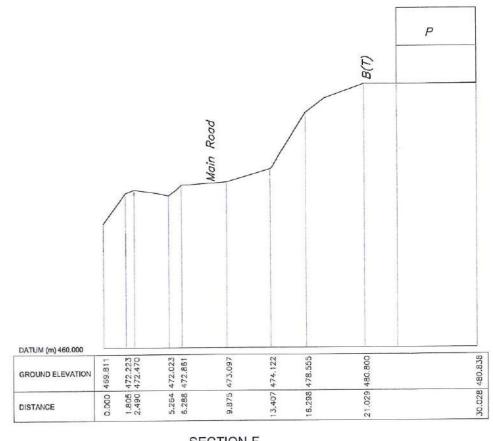

SECTION-D

SECTION-F

EMPLOYER

DEMOCRATIC SOCIALIST REPUBLIC OF SRI LANKA STATE MINISTRY OF INTERNAL SECURITY, HOME AFFAIRS AND DISASTER MANAGEMENT NATIONAL BUILDING RESEARCH ORGANISATION No. 99/1 ,JAWATTA ROAD


COLOMBO - 05

DESIGNER


DESIGN UNIT NATIONAL BUILDING RESEARCH ORGANISATION No. 99/1, JAWATTA ROAD, COLOMBO - 05

| PROJECT TITLE | APPROVAL | REVISION DESCRIPTION | DATE | REV |
|---------------|----------|----------------------|------|-----|
| RE | | | | |
| VULNERAL | | | | |
| DISTRIC | | | | |
| | | | - | |


| TITLE | DESCRIPTION NAME | | | NAME | SIGNATURE | |
|-------|------------------------------------|-----------------------|----------------|----------|-------------------|-----------|
| | | | | SURVEYED | KAMAL DESHAPRIYA | SIGNATURE |
| | SURVEY CRO | SURVEY CROSS SECTIONS | | DRAWN | M. H. M. HARSHANI | |
| | | | | | | |
| CALE | E 1: 300 DATE 02.11.2020 | | | | | |
| | T / DRAWING No. P/WORKS/NCB/04/ | | REVISION 00 | | | |

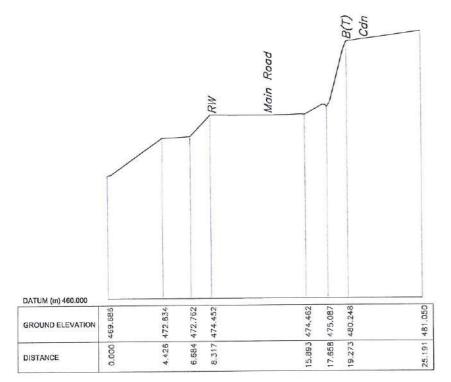


SECTION-G

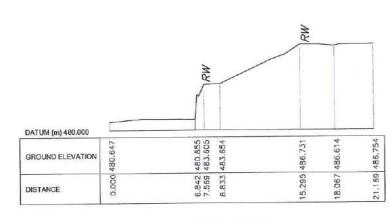


SECTION-H

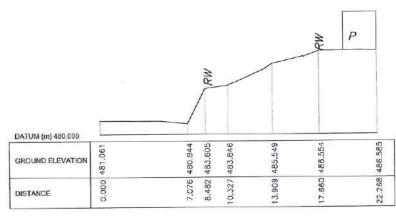


SECTION-I

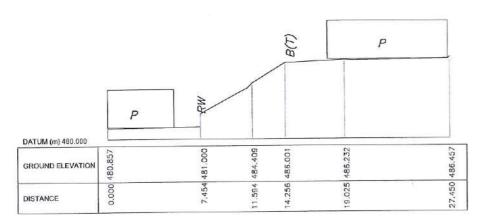

SECTION-J

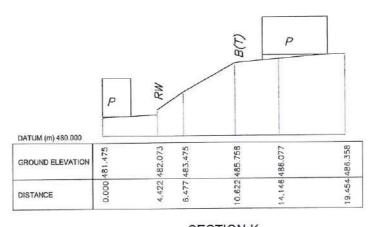

SECTION-K

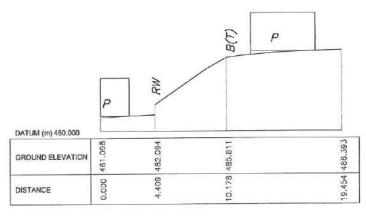

SECTION-L

| 11 | Ľ | UY | E | < |
|----|-----|----|---|---|
| 3 | (A) | | | |
| á | | A | | |
| ŧ, | æ | П | | |
| | œ | w | | |
| 73 | | - | | |

DEMOCRATIC SOCIALIST REPUBLIC OF SRI LANKA
STATE MINISTRY OF INTERNAL SECURITY, HOME AFFAIRS
AND DISASTER MANAGEMENT
NATIONAL BUILDING RESEARCH ORGANISATION
No. 99/1, JAWATTA ROAD


COLOMBO - 05


DESIGNER

DESIGN UNIT
NATIONAL BUILDING RESEARCH ORGANISATION
No. 99/1, JAWATTA ROAD,
COLOMBO - 05


| RE | DATE | REVISION DESCRIPTION | APPROVAL | PROJECT TITLE |
|----|------|----------------------|----------|---------------|
| | | | | |
| - | - | | | RI |
| | | | | VULNERA |
| | | | | DISTRIC |
| | | | - | |


| TITLE | | | | DESCRIPTION | NAME | SIGNATURE |
|-------------------------|-------|------|----------------|-------------|-------------------|-----------|
| | | | | SURVEYED | KAMAL DESHAPRIYA | |
| SURVEY CROSS SECTIONS | | | | DRAWN | M. H. M. HARSHANI | |
| | | | | | | |
| SCALE | 1:300 | DATE | 02.11.2020 | | | |
| 1 HOSEOT / BIGHTING HE. | | | REVISION 00 | | | |

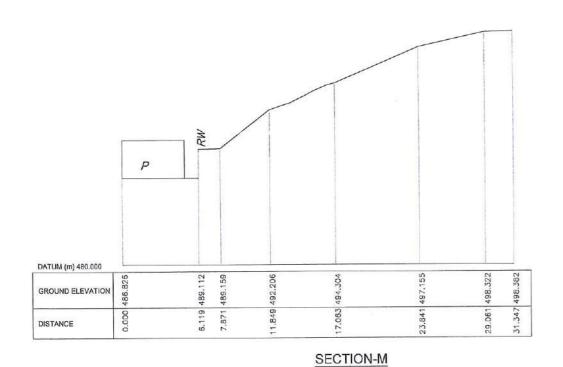

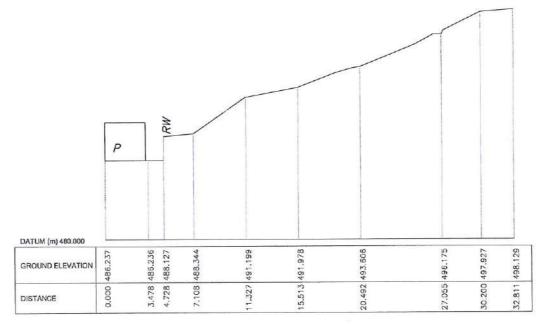

SECTION-N

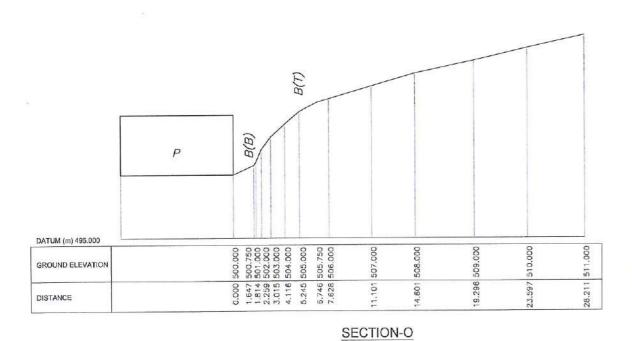

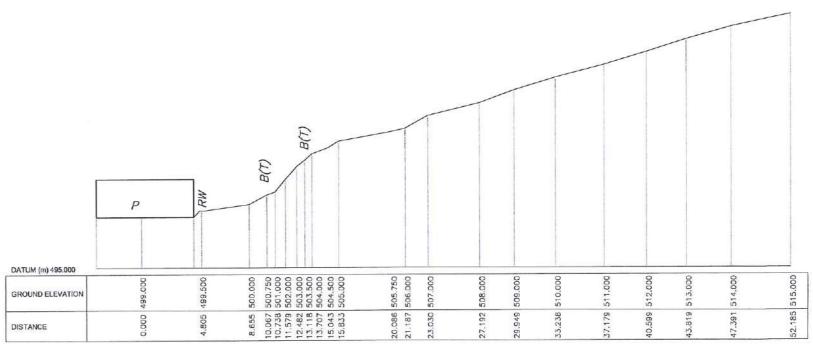

SECTION-P

DEMOCRATIC SOCIALIST REPUBLIC OF SRI LANKA
STATE MINISTRY OF INTERNAL SECURITY, HOME AFFAIRS
AND DISASTER MANAGEMENT
NATIONAL BUILDING RESEARCH ORGANISATION
No. 99/1 ,JAWATTA ROAD
COLOMBO - 05

DESIGNER

DESIGN UNIT


NATIONAL BUILDING RESEARCH ORGANISATION

No. 99/1, JAWATTA ROAD,


COLOMBO - 05

| PROJECT TITLE | APPROVAL | REVISION DESCRIPTION | DATE | REV |
|---------------|----------|----------------------|------|-----|
| R | | | | |
| VULNERA | | | | |
| DISTRIC | | | | |
| | | | | |

| TITLE | TITLE | | | DESCRIPTION | NAME | SIGNATURE |
|-------|----------------------------------|-----------------------|----------------|-------------|-------------------|-----------|
| | | | | SURVEYED | KAMAL DESHAPRIYA | |
| | SURVEY CROSS SECTIONS | | | DRAWN | M. H. M. HARSHANI | |
| | | | | | | |
| SCALE | 1:300 | DATE | 02.11.2020 | | | |
| | T / DRAWING NO P/WORKS/NCB/04 | o. 4A/20-Dc/DR-02c | REVISION 00 | | | |

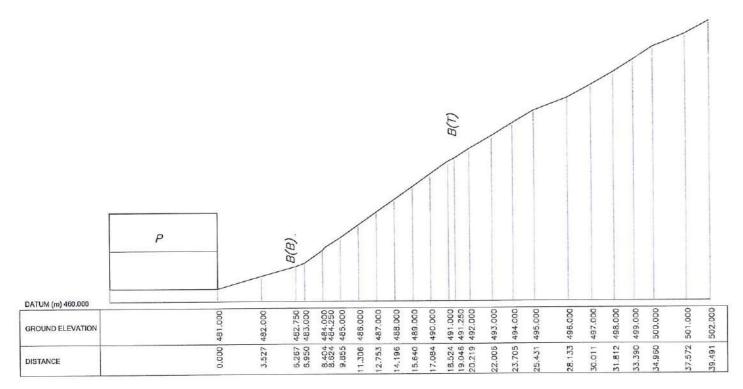



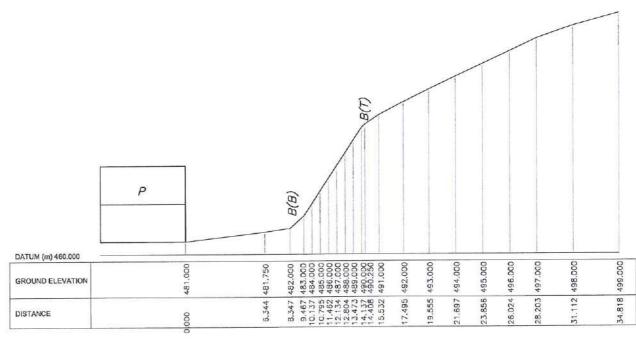

SECTION-R

EMPLOYER

DEMOCRATIC SOCIALIST REPUBLIC OF SRI LANKA
STATE MINISTRY OF INTERNAL SECURITY, HOME AFFAIRS
AND DISASTER MANAGEMENT
NATIONAL BUILDING RESEARCH ORGANISATION
No. 99/1 ,JAWATTA ROAD
COLOMBO - 05


DESIGNER


DESIGN U


DESIGN UNIT
NATIONAL BUILDING RESEARCH ORGANISATION
No. 99/1, JAWATTA ROAD,
COLOMBO - 05

| R |
|---------|
| VULNERA |
| DISTRIC |

| TITLE | | | DESCRIPTION | NAME | SIGNATURE |
|---|------|------------|-------------------|------------------|-----------|
| | | | SURVEYED | KAMAL DESHAPRIYA | |
| SURVEY CROSS SECTIONS | | DRAWN | M. H. M. HARSHANI | | |
| | | | | | |
| SCALE 1:300 | DATE | 02.11.2020 | | | |
| PROJECT / DRAWING No. REVISION RLVMMP/WORKS/NCB/04A/20-Dc/DR-02d 00 | | | | | |

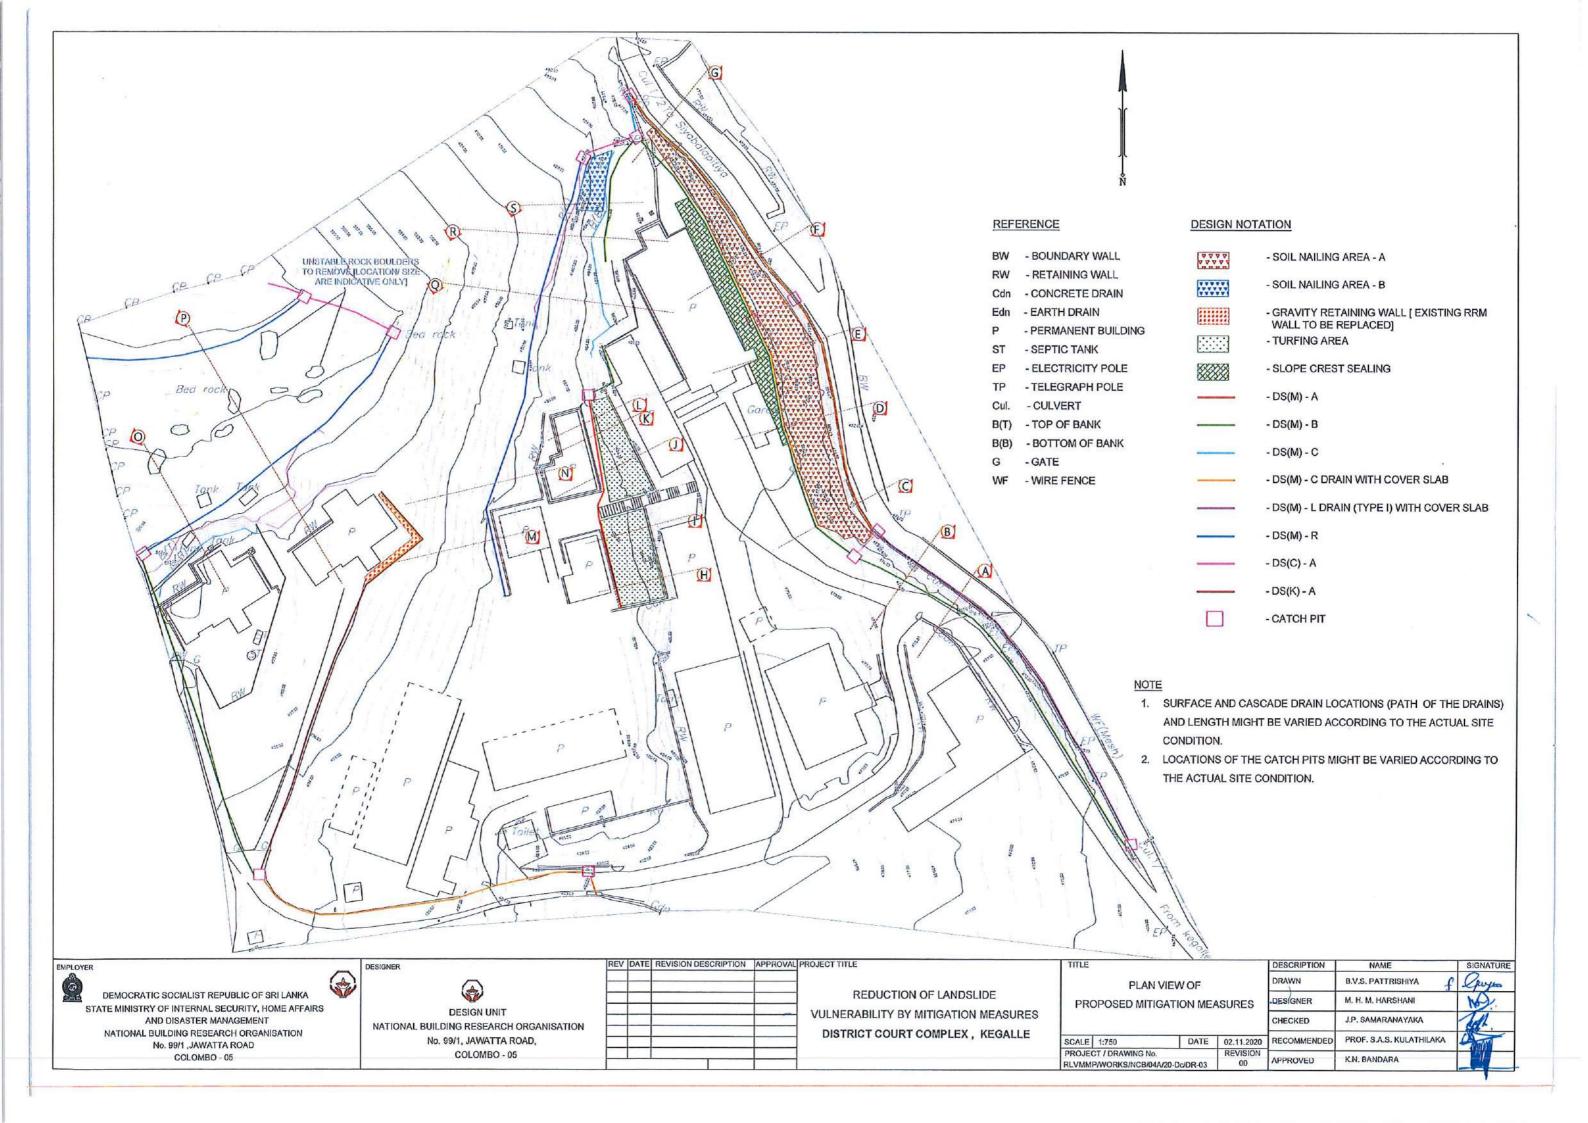

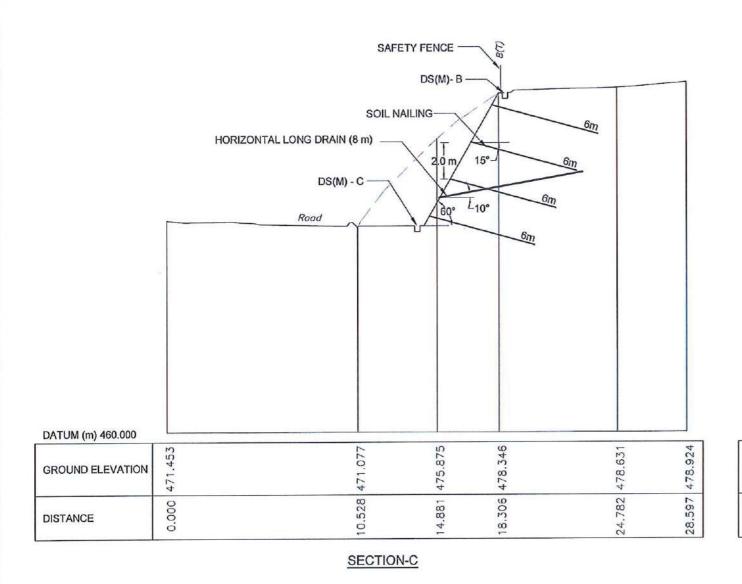

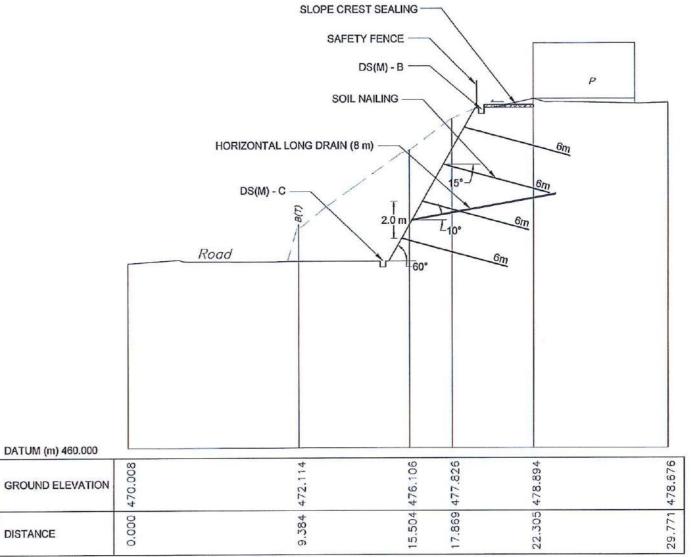

SECTION-D

TITLE

NOTE

LENGTH OF THE SOIL NAILS, LENGTH & LOCATION OF HORIZONTAL DRAINS MIGHT BE VARIED ACCORDING TO THE ACTUAL SOIL PROFILE OR SITE CONDITION.

EMPLOYER

DEMOCRATIC SOCIALIST REPUBLIC OF SRI LANKA STATE MINISTRY OF INTERNAL SECURITY, HOME AFFAIRS AND DISASTER MANAGEMENT NATIONAL BUILDING RESEARCH ORGANISATION No. 99/1 ,JAWATTA ROAD COLOMBO - 05

DESIGNER


DESIGN UNIT NATIONAL BUILDING RESEARCH ORGANISATION No. 99/1, JAWATTA ROAD, COLOMBO - 05


| REV | DATE | REVISION DESCRIPTION | APPROVAL | PROJECT TITLE |
|-----|------|----------------------|----------|--------------------------------------|
| | | | | REDUCTION OF LANDSLIDE |
| | | | | VULNERABILITY BY MITIGATION MEASURES |
| | | | | DISTRICT COURT COMPLEX, KEGALLE |

| LIDE | CROSS SECTIONS OF PROPOSEI |
|----------|----------------------------|
| LIDE | MITIGATION MEASURES |
| MEASURES | |

| CROSS SECTIONS OF PROPOSED | | | | |
|----------------------------|----------------|----------|------------|-------|
| MITIGATION MEASURES | | | | |
| | | | | CHECK |
| CALE | 1: 200 | DATE | 02.11.2020 | RECOM |
| ROJE | CT / DRAWING N | REVISION | APPRO | |

| ESCRIPTION | NAME | SIGNATURE |
|------------|--------------------------|-----------|
| RAWN | B.V.S. PATTRISHIYA | gayas |
| ESIGNER | M. H. M. HARSHANI | 102- |
| HECKED | J.P. SAMARANAYAKA | Tedler |
| ECOMMENDED | PROF. S.A.S. KULATHILAKA | - |
| PPROVED | K.N. BANDARA | 1941 |

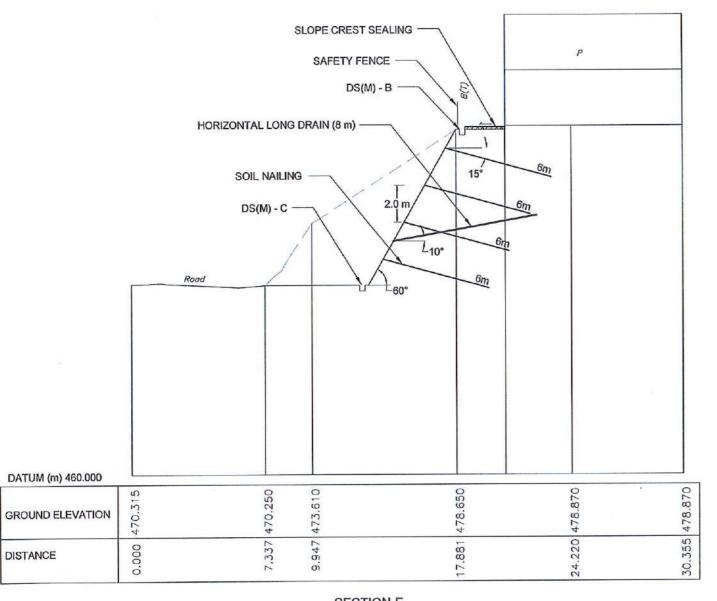

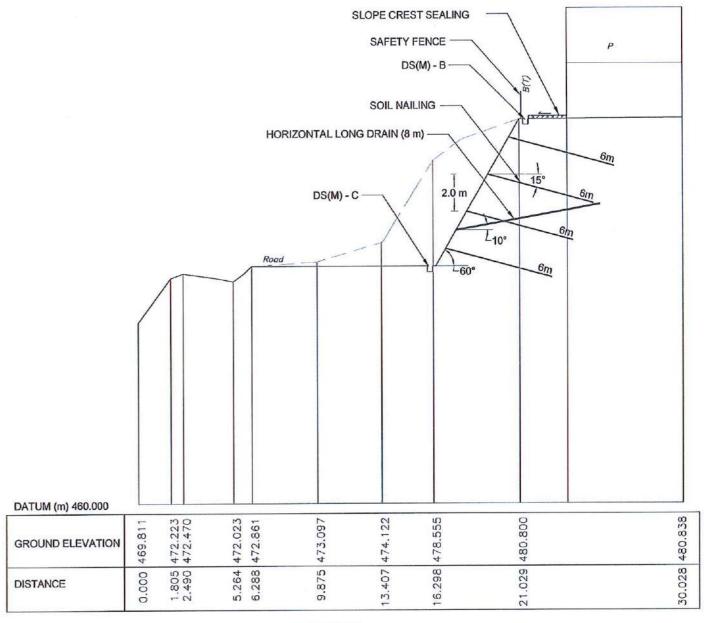

SECTION-F

SECTION-E

NOTE

 LENGTH OF THE SOIL NAILS, LENGTH & LOCATION OF HORIZONTAL DRAINS MIGHT BE VARIED ACCORDING TO THE ACTUAL SOIL PROFILE OR SITE CONDITION.

MPLOYER

DEMOCRATIC SOCIALIST REPUBLIC OF SRI LANKA
STATE MINISTRY OF INTERNAL SECURITY, HOME AFFAIRS
AND DISASTER MANAGEMENT
NATIONAL BUILDING RESEARCH ORGANISATION
No. 99/1 ,JAWATTA ROAD
COLOMBO - 05

DESIGNER

DESIGN UNIT
NATIONAL BUILDING RESEARCH ORGANISATION
No. 99/1, JAWATTA ROAD,
COLOMBO - 05


| PROJECT TITLE | APPROVAL | REVISION DESCRIPTION | DATE | REV |
|---------------|----------|----------------------|------|-----|
| RI | | | | |
| VULNERA | | | | |
| DISTRIC | | | | |
| | | | | |

REDUCTION OF LANDSLIDE
VULNERABILITY BY MITIGATION MEASURES
DISTRICT COURT COMPLEX, KEGALLE

| TITLE | | | | DES |
|--------|------------------|-----------|------------|-----|
| CE | ROSS SECTIO | NS OF PRO | POSED | DRA |
| Ci | | N MEASURE | | DES |
| | | | | CHE |
| SCALE | 1: 200 | DATE | 02.11.2020 | REC |
| PROJEC | CT / DRAWING No. | | REVISION | 1 |

RLVMMP/WORKS/NCB/04A/20-Dc/DR-04b 00

| DESCRIPTION | NAME | SIGNATUR |
|-------------|--------------------------|----------|
| DRAWN | B.V.S. PATTRISHIYA | Garjos |
| DESIGNER | M. H. M. HARSHANI | No |
| CHECKED | J.P. SAMARANAYAKA | HAI. |
| RECOMMENDED | PROF. S.A.S. KULATHILAKA | A |
| APPROVED | K.N. BANDARA | (1) |

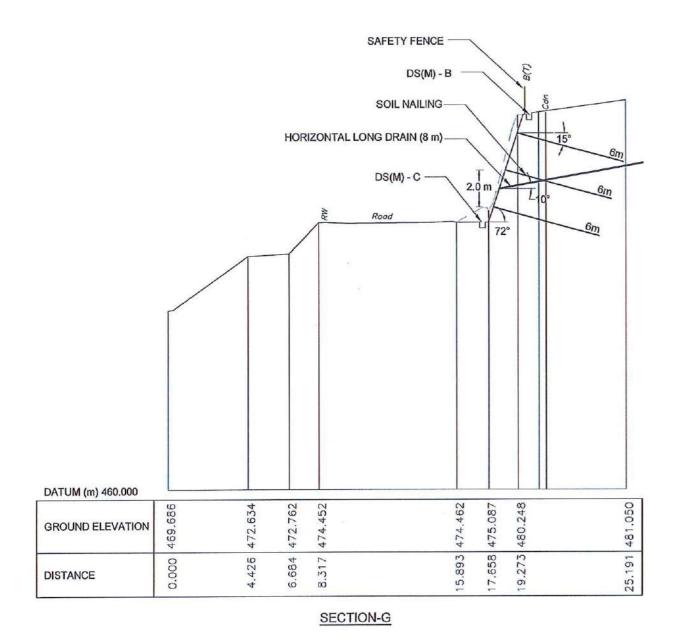

DS(M) - R HORIZONTAL LONG DRAIN (8 m) SOIL NAILING DS(M) - B-DATUM (m) 479.000 484.000 484.000 000. 486.000 GROUND ELEVATION 491 7.390 8.460 8.780 DISTANCE

SECTION-S

1. LENGTH OF THE SOIL NAILS, LENGTH & LOCATION OF HORIZONTAL DRAINS MIGHT BE VARIED ACCORDING TO THE ACTUAL SOIL PROFILE OR SITE CONDITION.

DEMOCRATIC SOCIALIST REPUBLIC OF SRI LANKA STATE MINISTRY OF INTERNAL SECURITY, HOME AFFAIRS AND DISASTER MANAGEMENT NATIONAL BUILDING RESEARCH ORGANISATION No. 99/1 ,JAWATTA ROAD COLOMBO - 05

DESIGNER

DESIGN UNIT NATIONAL BUILDING RESEARCH ORGANISATION No. 99/1, JAWATTA ROAD, COLOMBO - 05


| PROJECT TITLE | APPROVAL | REVISION DESCRIPTION | DATE | REV |
|---------------|----------|----------------------|------|-----|
| RE | | | | |
| VULNERA | | | | |
| DISTRIC | | | | |
| | | | | |

REDUCTION OF LANDSLIDE **VULNERABILITY BY MITIGATION MEASURES** DISTRICT COURT COMPLEX, KEGALLE

| TITLE | | | |
|--------|------------------|----------------|----------------|
| CF | ROSS SECTIO | NS OF PROF | |
| | WITIGATIO | N WEASONE | 3 |
| SCALE | 1: 200 | DATE | 02.11.2020 |
| PROJEC | CT / DRAWING No. | A/20-Dc/DR-04c | REVISION 00 |

RLVMMP/WORKS/NCB/04A/20-Dc/DR-04c

| DESCRIPTION | NAME | SIGNATURE |
|-------------|--------------------------|-----------|
| DRAWN | B.V.S. PATTRISHIYA | Gaygo |
| DESIGNER | M. H. M. HARSHANI | M |
| CHECKED | J.P. SAMARANAYAKA | 14 |
| RECOMMENDED | PROF. S.A.S. KULATHILAKA | |
| APPROVED | K.N. BANDARA | |

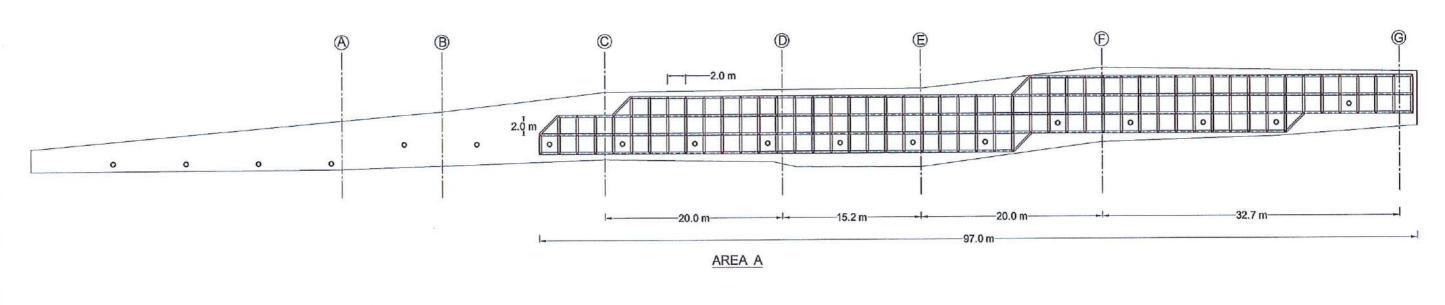

LEGEND

SOIL NAILING -

TOTAL NAIL LENGTH= 6 m

NO'S OF NAIL = 183 SOIL NAIL DIAMETER = 32 mm

DIAMETER OF THE DRILLED HOLE = 125 mm


NAIL SPACING = 2.0 m

O HORIZONTAL LONG DRAIN -

HORIZONTAL LONG DRAIN LENGTH = 8 m

NO'S OF LONG DRAIN = 18

DIAMETER = 90 mm

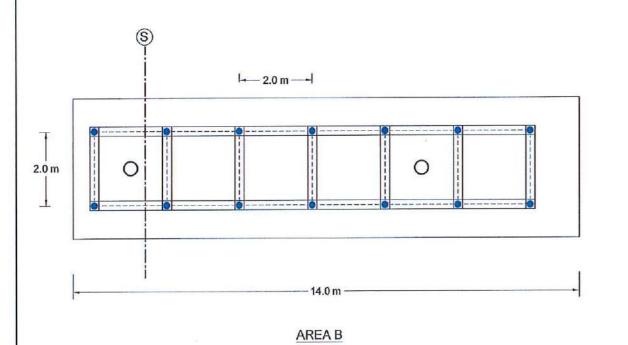

LEGEND

SOIL NAILING -

TOTAL NAIL LENGTH= 6 m

NO'S OF NAIL = 14

SOIL NAIL DIAMETER = 32 mm

DIAMETER OF THE DRILLED HOLE = 125 mm

NAIL SPACING = 2.0 m

O HORIZONTAL LONG DRAIN -

HORIZONTAL LONG DRAIN LENGTH = 8 m

NO'S OF LONG DRAIN = 02

DIAMETER = 90 mm

NOTE


- 1. INSTALLED LENGTHS OF THE SOIL NAILS MIGHT BE VARIED ACCORDING TO THE ACTUAL SOIL PROFILE OR SITE CONDITION.
- 2. LOCATION AND LENGTH OF THE HORIZONTAL LONG DRAINS WILL BE DECIDED ACCORDING TO THE ACTUAL SITE CONDITION.
- SOIL NAIL SLOPE NEAR SECTION C SHALL END WITH SMOOTH TRANSITION TO MATCH WITH EXISTING SLOPE.



DEMOCRATIC SOCIALIST REPUBLIC OF SRI LANKA STATE MINISTRY OF INTERNAL SECURITY, HOME AFFAIRS AND DISASTER MANAGEMENT NATIONAL BUILDING RESEARCH ORGANISATION No. 99/1 ,JAWATTA ROAD COLOMBO - 05



DESIGN UNIT NATIONAL BUILDING RESEARCH ORGANISATION No. 99/1, JAWATTA ROAD, COLOMBO - 05

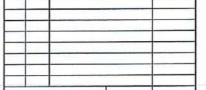

REV DATE REVISION DESCRIPTION | APPROVAL PROJECT TITLE


REDUCTION OF LANDSLIDE **VULNERABILITY BY MITIGATION MEASURES** DISTRICT COURT COMPLEX, KEGALLE

| PROP | |
|-------|-----------|
| SURES | 5 |
| | |
| DATE | 02.11.202 |
| | DATE |


PROJECT / DRAWING No.


RLVMMP/WORKS/NCB/04A/20-Dc/DR-05

| | DESCRIPTION | NAME | SIGNATURE |
|------------|-------------|--------------------------|-----------|
| DSED | DRAWN | B,V.S. PATTRISHIYA | Claye |
| JOED | DESIGNER | M. H. M. HARSHANI | M |
| | CHECKED | J.P. SAMARANAYAKA | 141 |
| 02.11.2020 | RECOMMENDED | PROF. S.A.S. KULATHILAKA | all |
| REVISION | APPROVED | K.N. BANDARA | VM) |

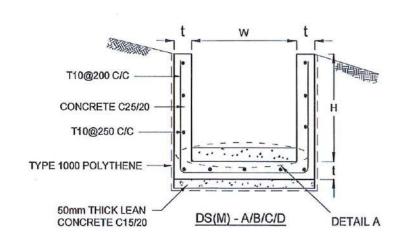

| DRAIN TYPE | W (mm) | H (mm) | t (mm) |
|---------------|--------|--------|--------|
| DS (M) - A /P | 300 | 300 | 100 |
| DS (M) - B/R | 450 | 450 | 100 |
| DS (M) - C/Q | 600 | 600 | 100 |
| DS (M) - D | 750 | 750 | 125 |
| DS (M) - E | 900 | 900 | 150 |
| DS (M) - F | 1000 | 1000 | 150 |

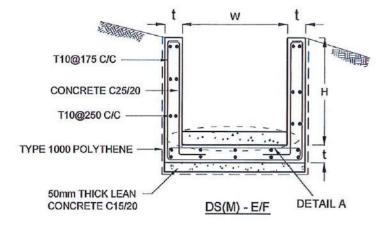

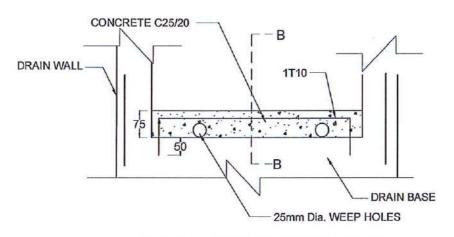

DETAIL A - (ENERGY BREAKER AT 3M)

NOTES


- DEPTH OF EXCAVATION MAY VARY ACCORDING TO SITE CONDITIONS.
- STEPS SHALL BE CONSTRUCTED AT SURFACE DRAIN ON SLOPING GROUND ACCORDING TO THE SITE CONDITIONS AS INSTRUCTED BY THE ENGINEER.
- ENERGY BREAKERS SHALL BE CONSTRUCTED AT THE STEEP DRAIN SEGMENTS AS PER THE INSTRUCTIONS OF THE ENGINEER.
- DOWELS SHALL BE INSTALLED ACCORDING TO THE GROUND CONDITIONS AS INSTRUCTED BY THE ENGINEER.
- ALL DIMENSIONS ARE IN MILLIMETERS UNLESS OTHERWISE STATED.
- 6. 10 mm THICK EXPANSION JOINT SHALL BE INTRODUCED IN EVERY 5m INTERVAL.


CONCRETE


- USE FOLLOWING CONCRETE GRADES FOR STRUCTURE 7.
 - SCREED - C. 15/20
 - WALLS / BASE / ENERGY BREAKERS -C. 25/20

REINFORCEMENT

- ALL BARS MARKED "T" SHALL BE HIGH YIELD DEFORMED BARS OF YIELD STRENGTH NOT LESS THAN 460N/mm2.
- BARS OF CUT LENGTH LARGER THAN THE SUPPLIED LENGTH TO BE LAPPED FOR A LENGTH OF 50 x BAR DIA. AND LAPPING SHOULD BE STAGGERED.
- ANCHORAGE LENGTH SHOULD BE 40X BAR DIA.
- REINFORCEMENT BARS SHALL BE BENT IN ACCORDANCE WITH STANDARD SPECIFICATIONS.
- COVER TO REINFORCEMENT
 - BURIED FACES AND DRAIN INVERTS - 40 mm [a] [b]
 - **ALL OTHER FACES** - 25 mm

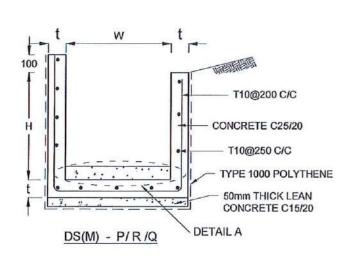

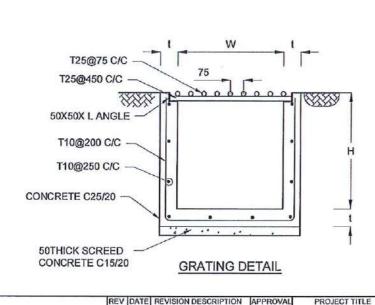

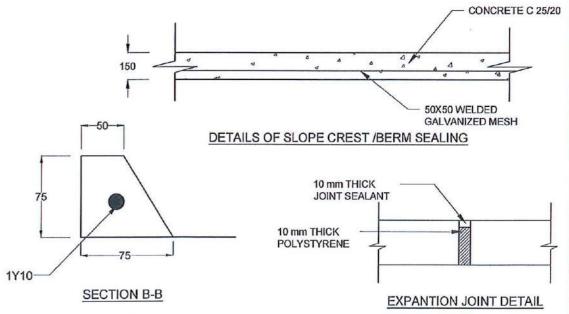

EMPLOYER DEMOCRATIC SOCIALIST REPUBLIC OF SRI LANKA STATE MINISTRY OF INTERNAL SECURITY, HOME AFFAIRS AND DISASTER MANAGEMENT NATIONAL BUILDING RESEARCH ORGANISATION No. 99/1, JAWATTA ROAD


COLOMBO - 05


DESIGN UNIT NATIONAL BUILDING RESEARCH ORGANISATION No. 99/1 ,JAWATTA ROAD COLOMBO - 05


DESIGNER


REDUCTION OF LANDSLIDE **VULNERABILITY BY MITIGATION MEASURES** DISTRICT COURT COMPLEX, KEGALLE

DESCRIPTION DRAWN B.V.S. PATTRISHIYA **DETAILS OF DRAINS** M. H. M. HARSHANI (SURFACE DRAIN -1 OF 2) DESIGNER J.P. SAMARANAYAKA CHECKED PROF. S.A.S. KULATHILAKA RECOMMENDED SCALE N.T.S. DATE 02.11.2020 PROJECT / DRAWING No. REVISION K.N. BANDARA RLVMMP/WORKS/NCB/04A/20-Dc/DR-06a

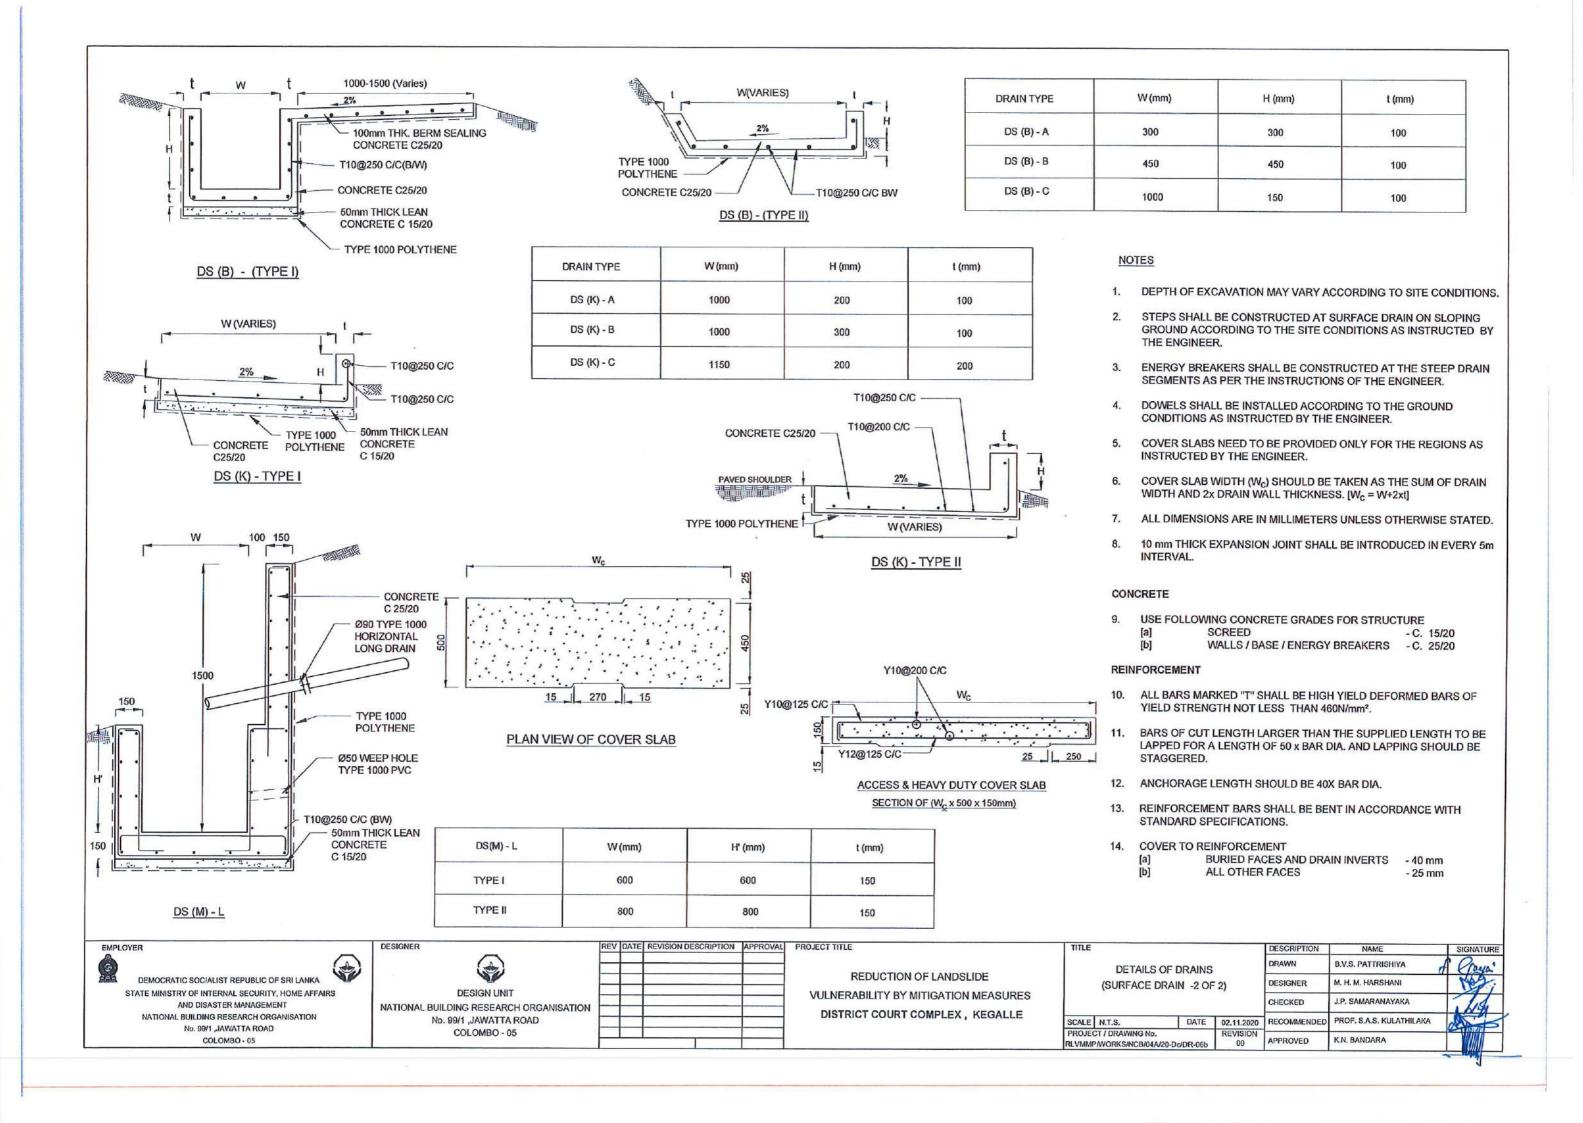

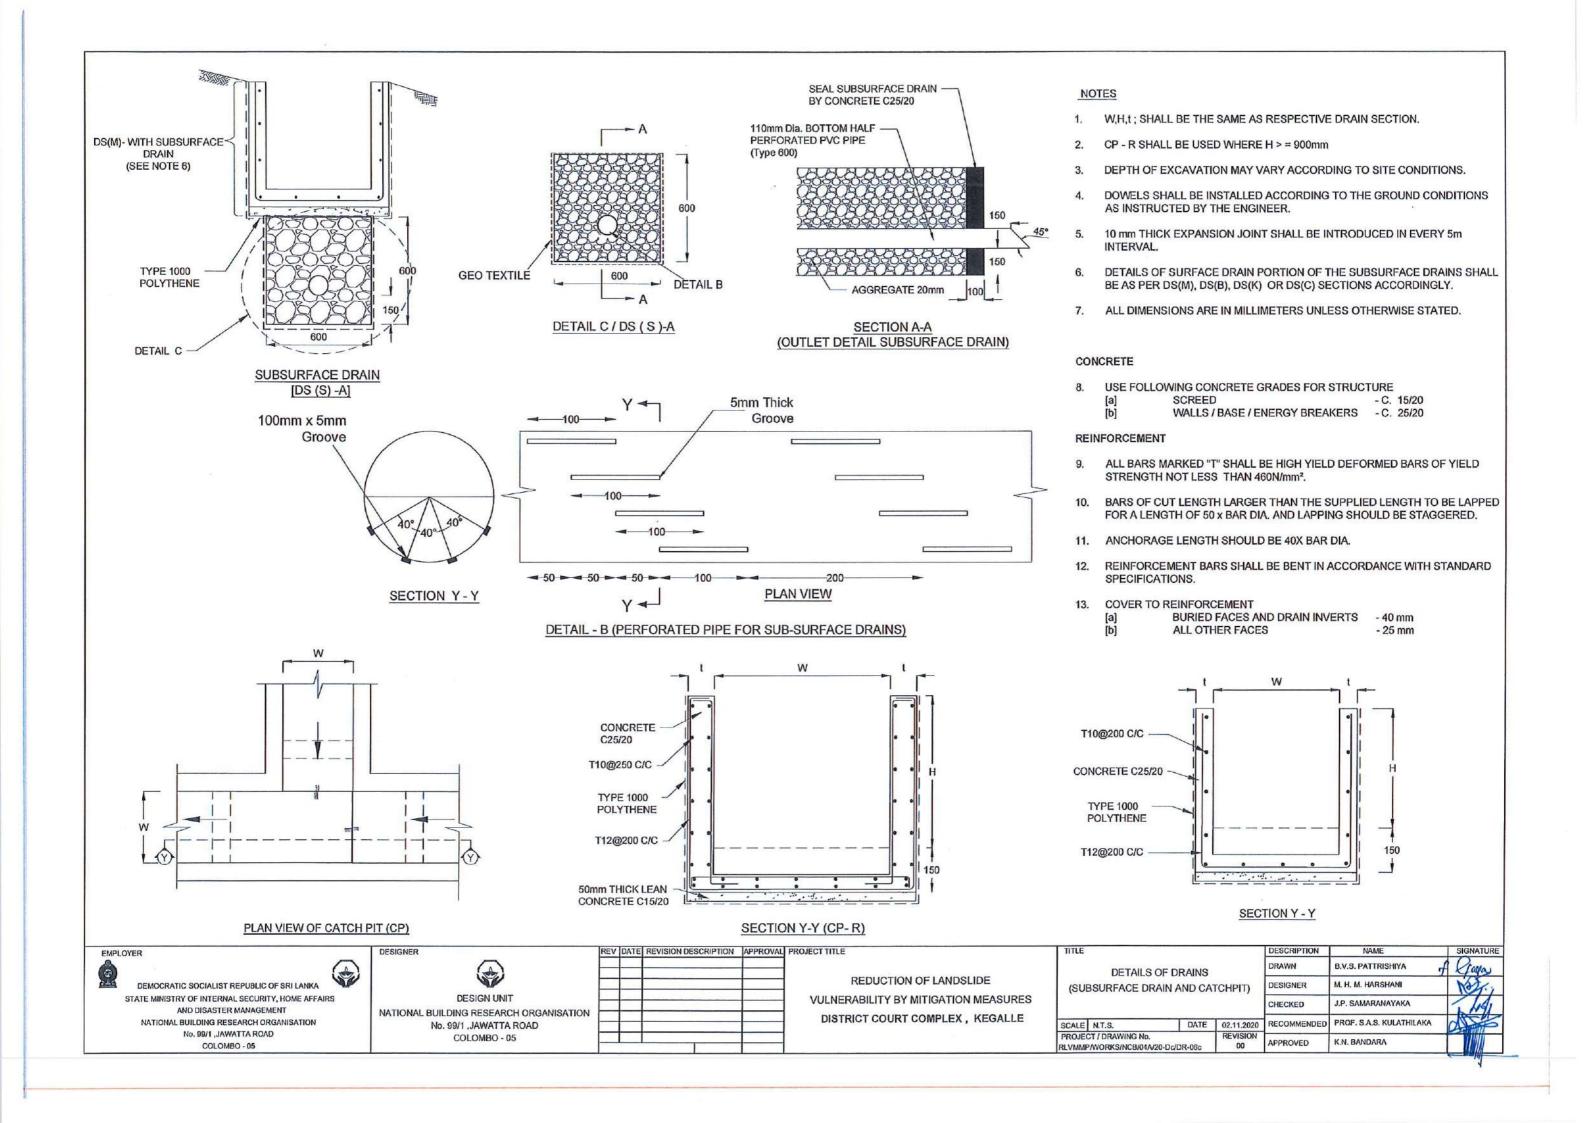

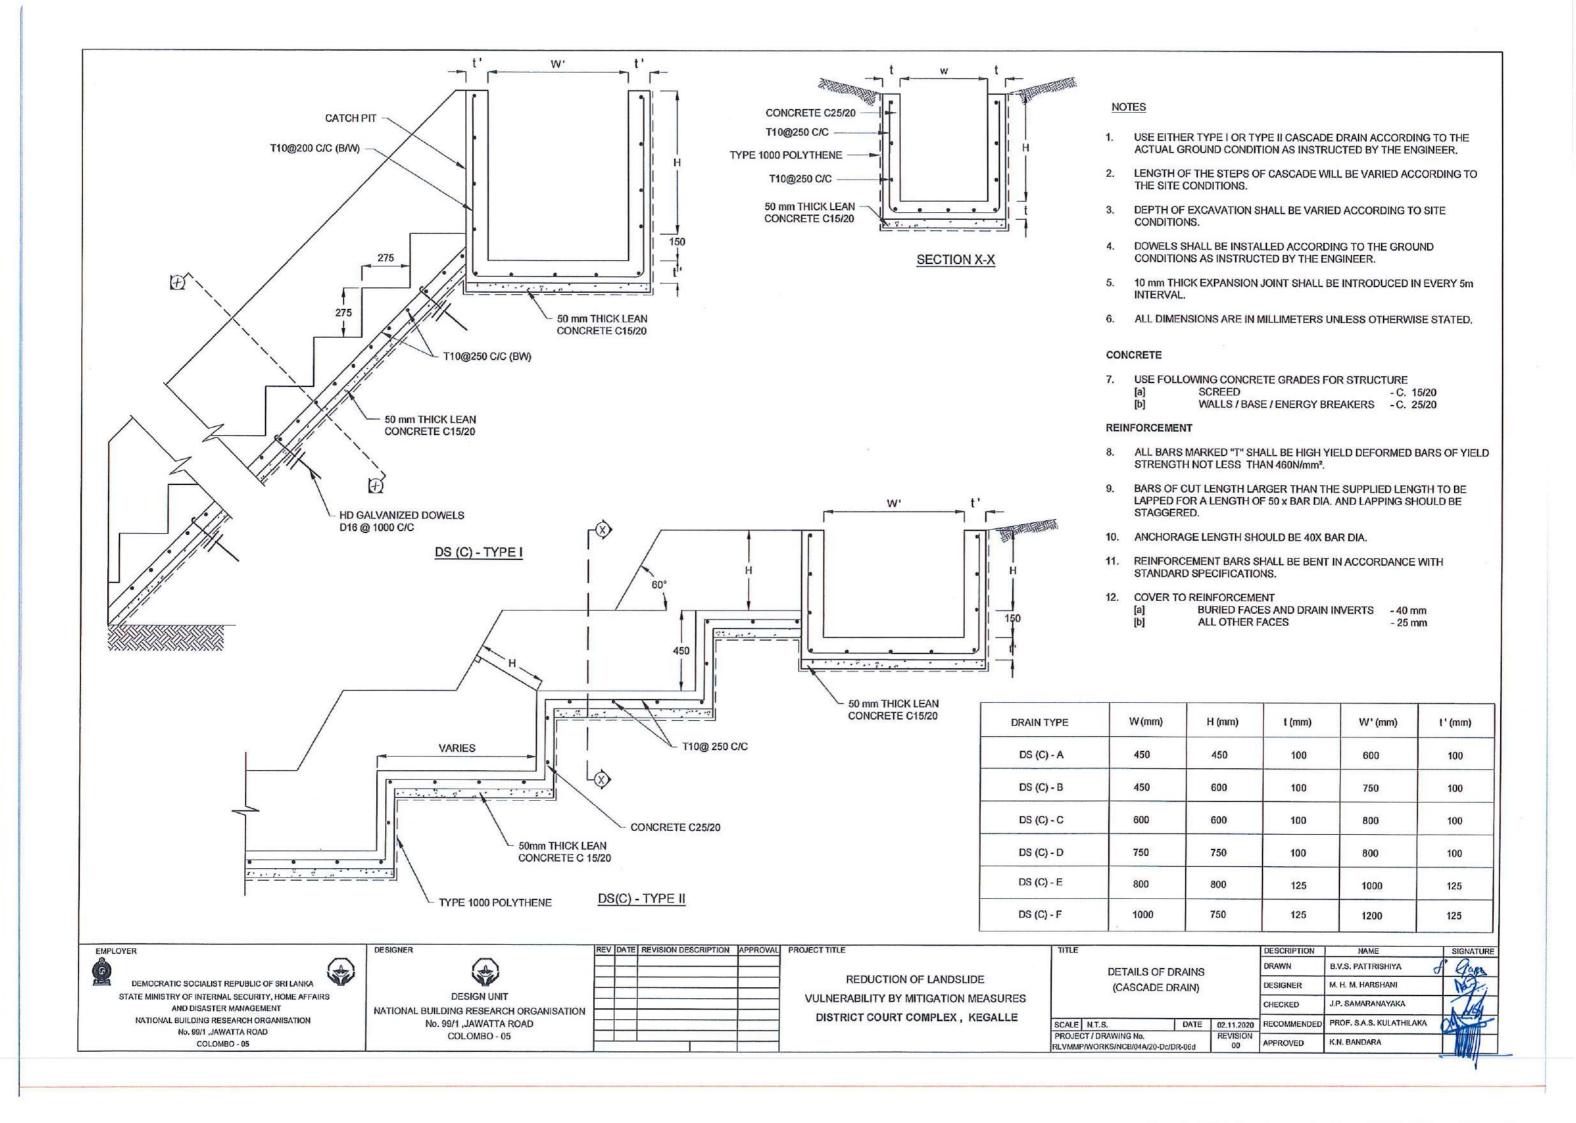

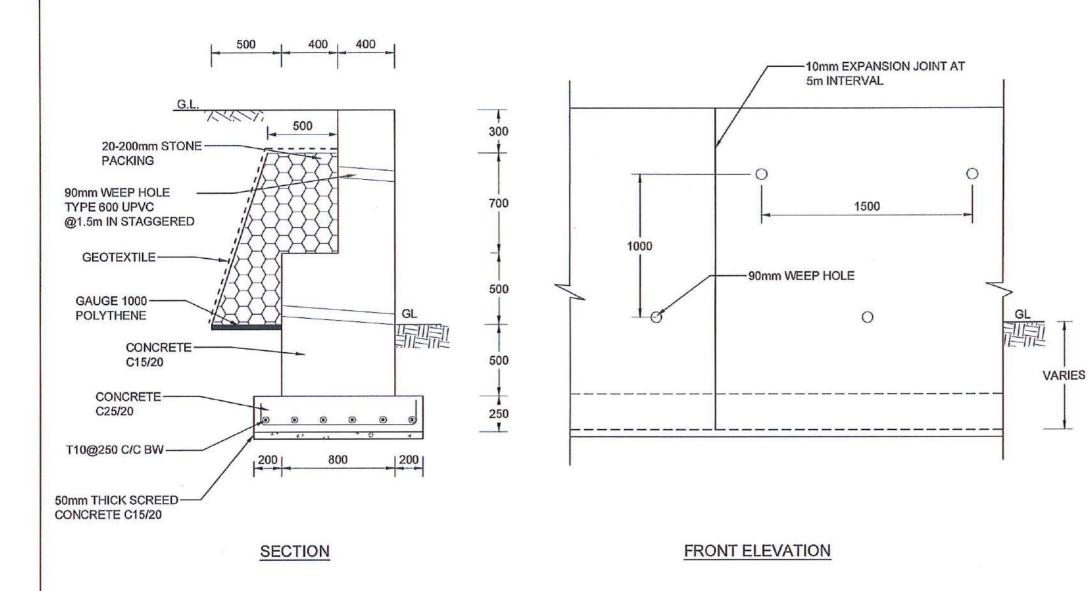

NOTES

- [a] ALL DIMENSION ARE IN MILLIMETERS UNLESS OTHERWISE SPECIFIED
- [b] POROUS BACKFILL ALONG THE ENTIRE LENGTH OF THE WALL AS INDICATED.
- [c] WEEP HOLES TO BE PROVIDED AT 1.5m C/C STAGGERED USING 90mm DIA UPVC PIPES.(TYPE 600)

CONCRETE

[d] USE FOLLOWING CONCRETE GRADES FOR STRUCTURES
[a] SCREED / WALL - C 15/20
[b] FOUNDATION BASE - C 25/20

REINFORCEMENTS

- [e] ALL BARS MARKED "T" SHALL BE HIGH YIELD DEFORMED BARS OF YIELD STRENGTH NOT LESS THAN 460N/mm².
- [f] BARS OF CUT LENGTH LARGER THAN THE SUPPLIED LENGTH TO BE LAPPED WITH LENGTH OF 50Ø, WHERE Ø IS THE DIAMETER. LAPPINGS SHOULD BE STAGGERED
- REINFORCEMENT BARS SHALL BE BENT IN ACCORDANCE WITH STANDARD SPECIFICATIONS.
- [h] CLEAR CONCRETE COVER FOR THE REINFORCEMENT BELLOW GROUND LEVEL SHALL BE 50mm.

SPECIAL NOTE

RLVMMP/WORKS/NCB/04A/20-Dc/DR-07

- [i] ALLOWABLE BEARING CAPACITY OF THE GROUND IS 150kPa.
- EXPANSION JOINTS SHALL BE PROVIDED AT 5m SPACES WITH APPROVED MATERIAL

EMPLOYER

DEMOCRATIC SOCIALIST REPUBLIC OF SRI LANKA
STATE MINISTRY OF INTERNAL SECURITY, HOME AFFAIRS
AND DISASTER MANAGEMENT
NATIONAL BUILDING RESEARCH ORGANISATION
No. 99/1, JAWATTA ROAD

COLOMBO - 05

DESIGNER

DESIGN U

DESIGN UNIT
NATIONAL BUILDING RESEARCH ORGANISATION
No. 99/1 ,JAWATTA ROAD
COLOMBO - 05

REV DATE REVISION DESCRIPTION APPROVAL

REDUCTION OF LANDSLIDE
VULNERABILITY BY MITIGATION MEASURES
DISTRICT COURT COMPLEX, KEGALLE

PROJECT TITLE

DETAILS OF CONCRETE

GRAVITY RETAINING WALL

SCALE N.T.S.

DATE 02.11.2020


RECOMMENDED PROF. S.A.S. KULATHILAKA
PROJECT / DRAWING No.


REVISION


REVISION


APPROVED


K.N. BANDARA

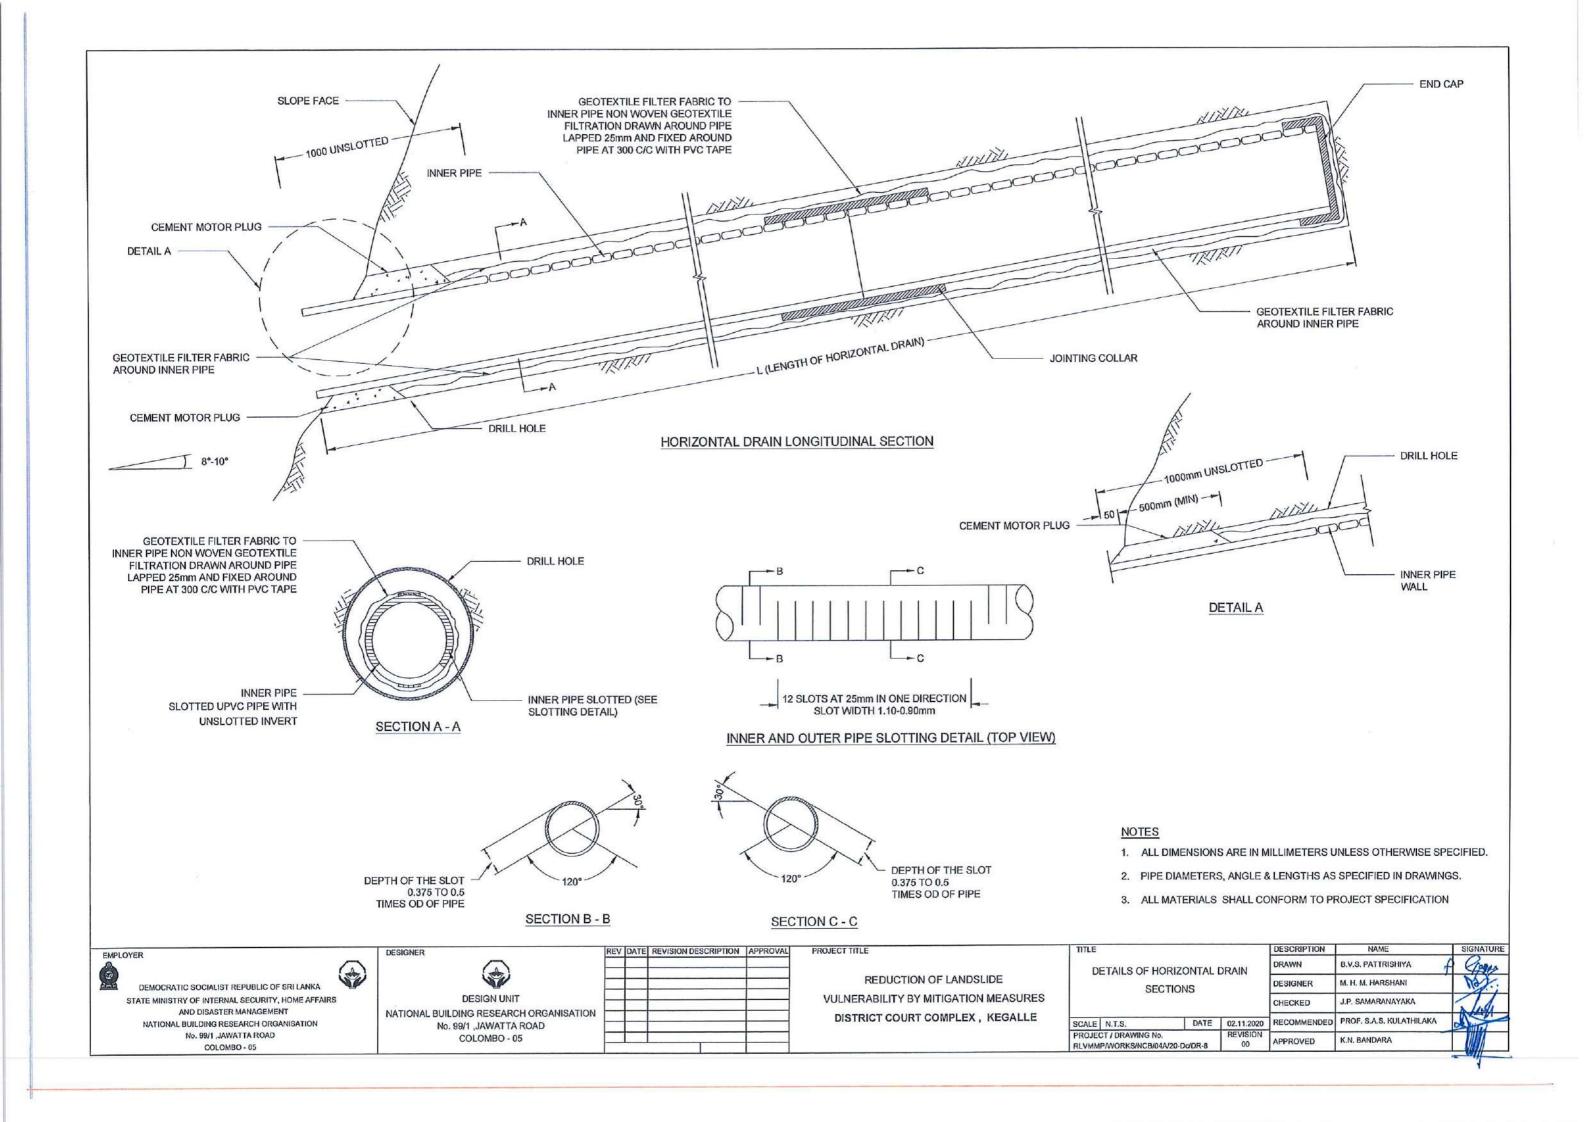

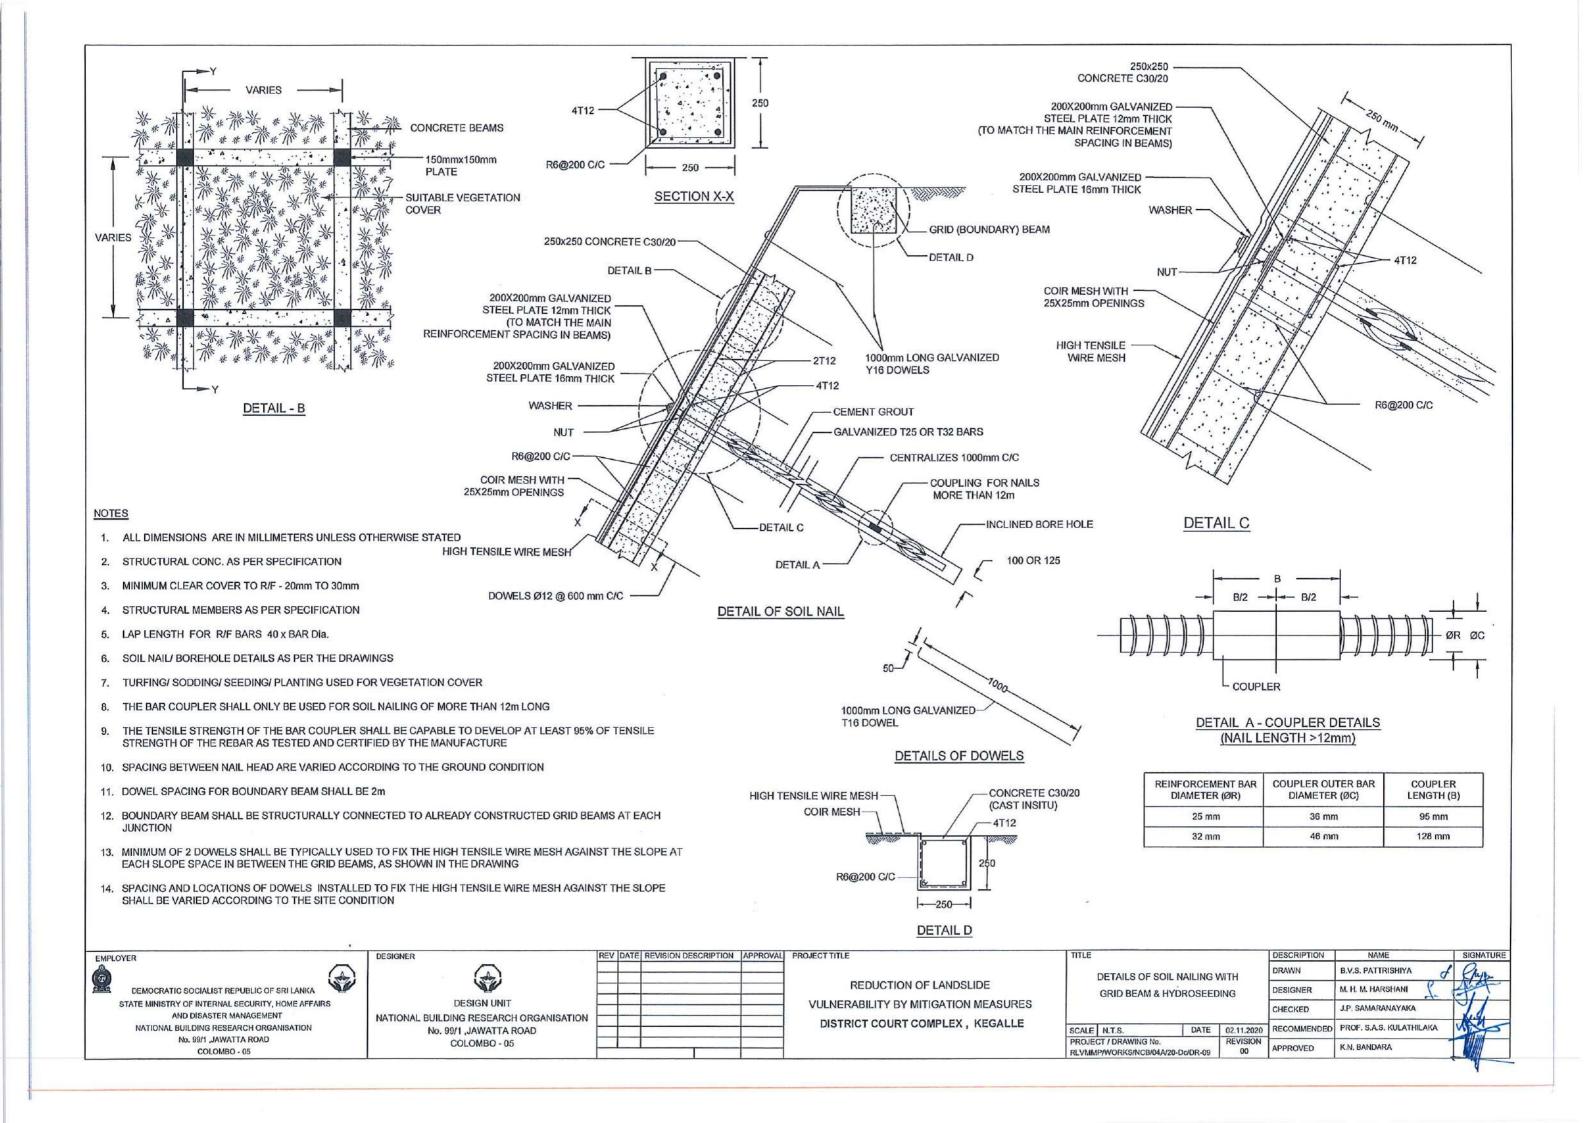

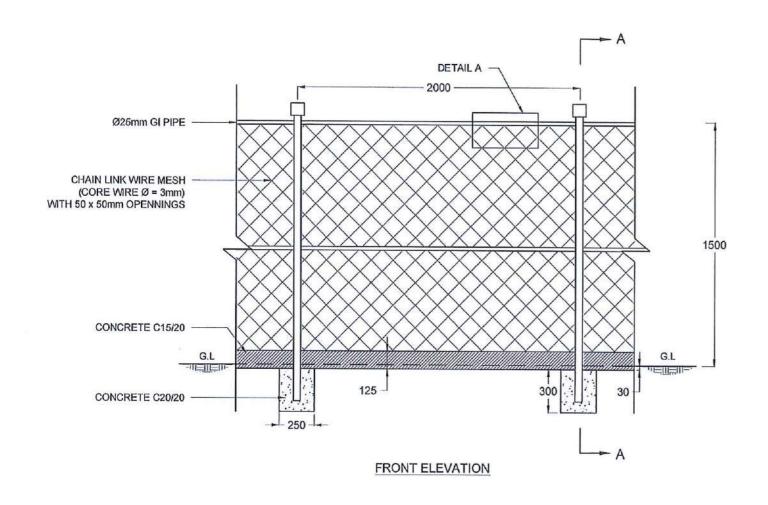

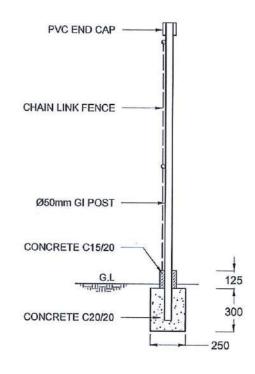

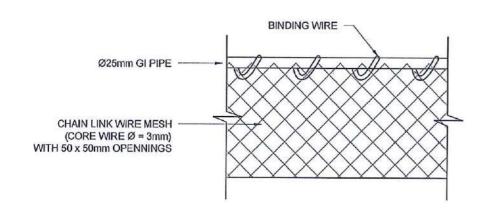

DETAIL A

NOTES

- 1. ALL DIMENSIONS ARE IN MILLIMETERS UNLESS OTHERWISE STATED
- 2. GI POST SHOULD BE COVERED WITH GREEN COLOUR ANTI-CORROSIVE PAINT

SECTION A - A

3. PRIOR APPROVAL IS REQUIRED FOR CHAIN LINK WIRE MESH, GI POST AND PVC CAP

EMPLOYER

DEMOCRATIC SOCIALIST REPUBLIC OF SRI LANKA
STATE MINISTRY OF INTERNAL SECURITY, HOME AFFAIRS
AND DISASTER MANAGEMENT
NATIONAL BUILDING RESEARCH ORGANISATION
No. 991 JAWATTA ROAD
COLOMBO - 05

DESIGNER

DESIGN UNIT
NATIONAL BUILDING RESEARCH ORGANISATION
No. 99/1 ,JAWATTA ROAD
COLOMBO - 05


| PROJECT TITL | APPROVAL | REVISION DESCRIPTION | DATE | REV |
|--------------|----------|----------------------|------|-----|
| VULNE | | | | |
| DIST | | | | |
| | | | | |

REDUCTION OF LANDSLIDE

VULNERABILITY BY MITIGATION MEASURES

DISTRICT COURT COMPLEX, KEGALLE

| TITLE | | | | DESCRIPTION | NAME | SIGNATURE |
|---|------------------|---------|----------------|-------------------|--------------------------|-----------|
| | DETAILS OF CHAIN | LINIZEE | NOE | DRAWN | B.V.S. PATTRISHIYA | Course |
| DETAILS OF CHAIN LINK FENCE | | | NCE | DESIGNER | M. H. M. HARSHANI | You. |
| | | | CHECKED | J.P. SAMARANAYAKA | 11 | |
| SCALE N.T.S. DATE 02.11.2020 | | | | RECOMMENDED | PROF. S.A.S. KULATHILAKA | |
| PROJECT / DRAWING No. REVISION REVISION NO. | | | REVISION 00 | APPROVED | K.N. BANDARA | |

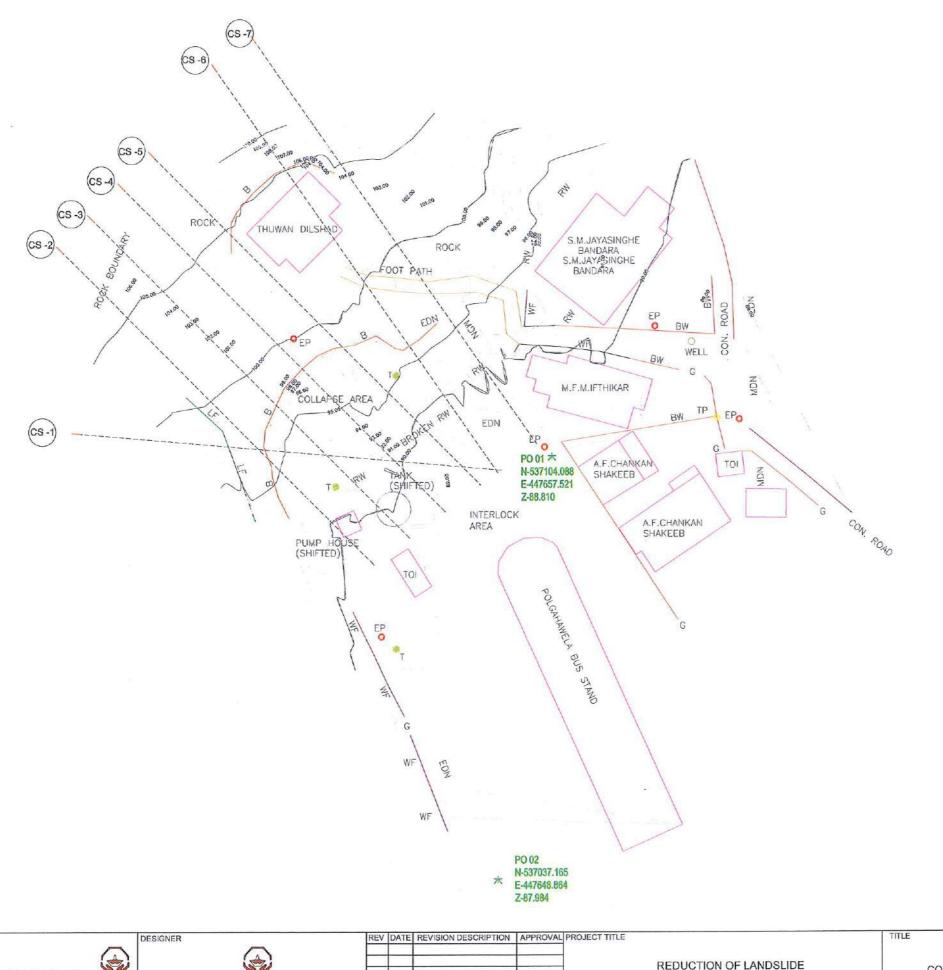



BD -BUILDING

BOUNDARY WALL

CULVERT CUL -

GATE

LIVE FENCE

MASONRY DRAIN

EARTH DRAIN

RW - RETAINING WALL

TOI - TOILET

WF - WIRE FENCE

EMPLOYER


DEMOCRATIC SOCIALIST REPUBLIC OF SRI LANKA STATE MINISTRY OF INTERNAL SECURITY, HOME AFFAIRS AND DISASTER MANAGEMENT NATIONAL BUILDING RESEARCH ORGANISATION No. 99/1 ,JAWATTA ROAD


COLOMBO - 05


| _ | DESIGNER | f |
|---|---|---|
| 1 | | H |
| | | ŀ |
| | DESIGN UNIT | F |
| | NATIONAL BUILDING RESEARCH ORGANISATION | ŀ |
| | No. 99/1 ,JAWATTA ROAD | ľ |
| | COLOMBO 05 | r |

| | REDUCTION OF LANDSLIDE |
|---|--------------------------------------|
| | VULNERABILITY BY MITIGATION MEASURES |
| | POLGAHAWELA BUS STAND |
| _ | POLGANAWELA BOS STAND |

| TITLE | | | | DESCRIPTION | NAME | SIGNATURE |
|-------|---|------|------------|-------------|------------------------|-----------|
| | | | | SURVEYED | LANKA G.P.S. (PVT) LTD | |
| | CONTOUR SURVEY PLAN | | | | B.I. KUMARAGE | |
| | | | | | | |
| SCALE | 1:500 | DATE | 12.11.2020 | | | |
| | PROJECT / DRAWING No. RLVMMP/WORKS/NCB/04A/07-PL/DR- 01 | | | | | |

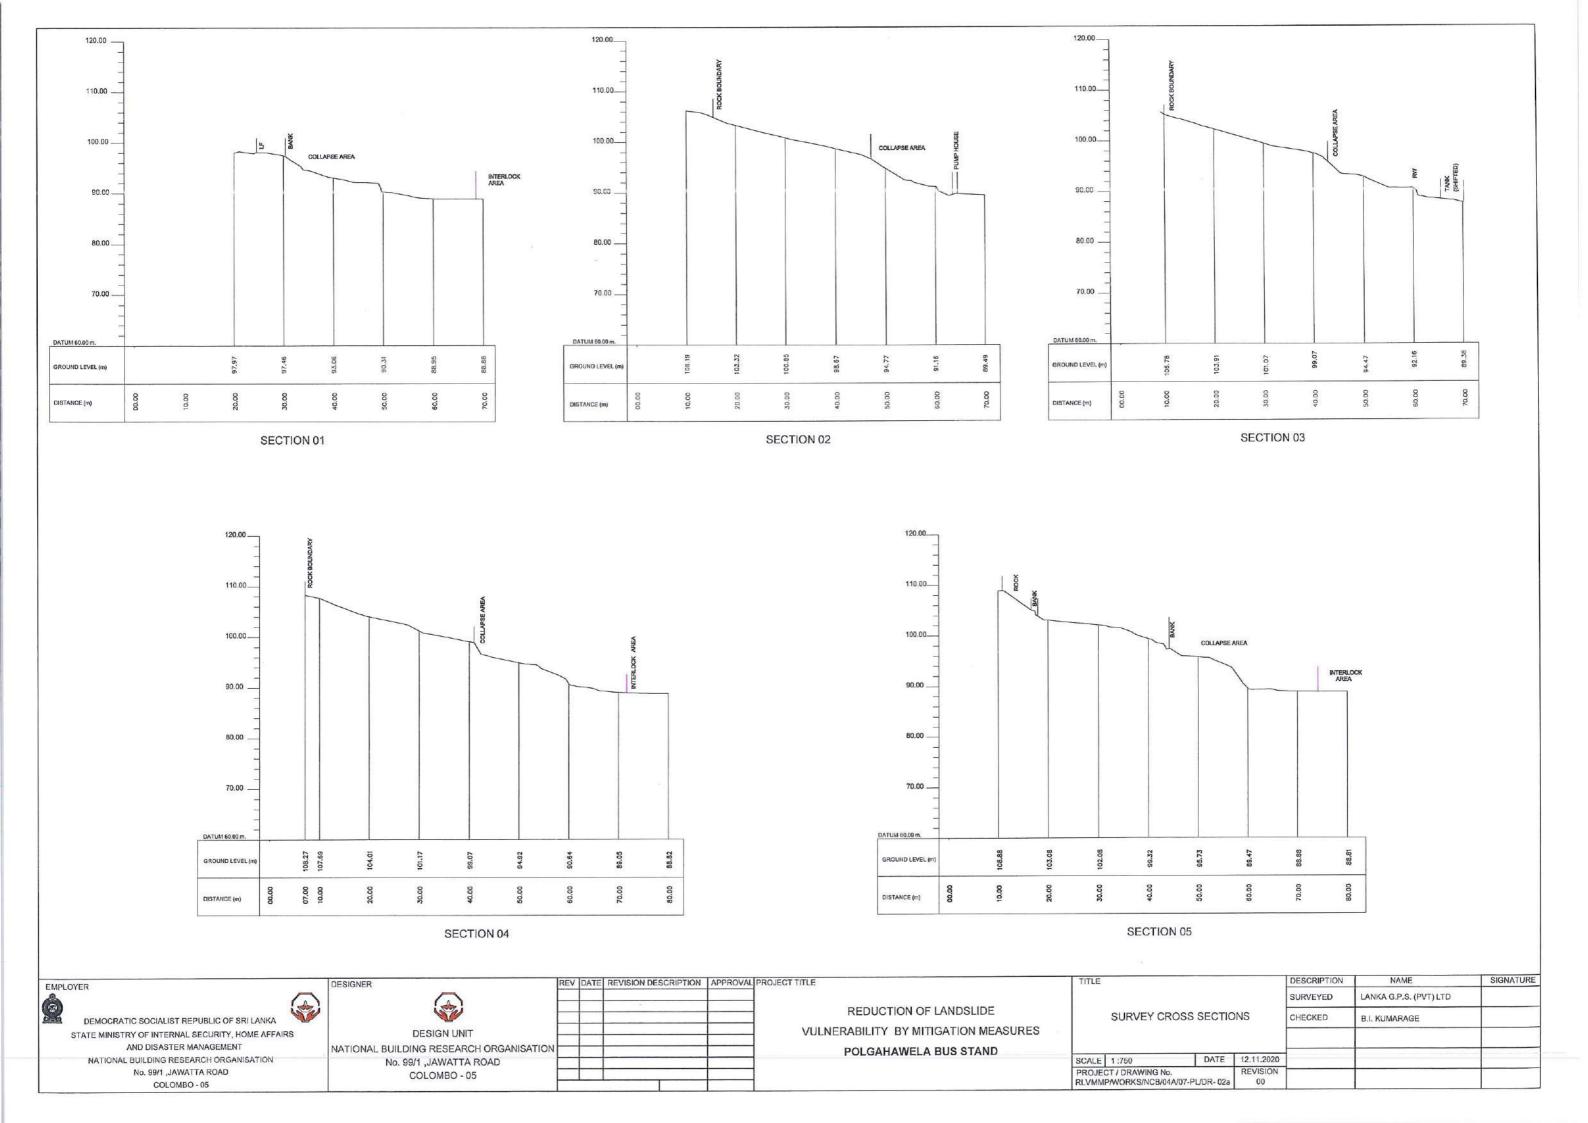

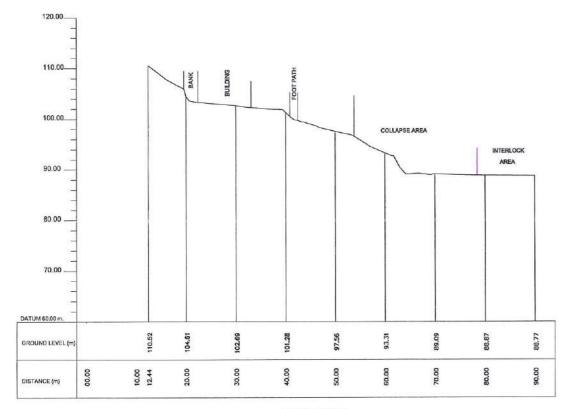

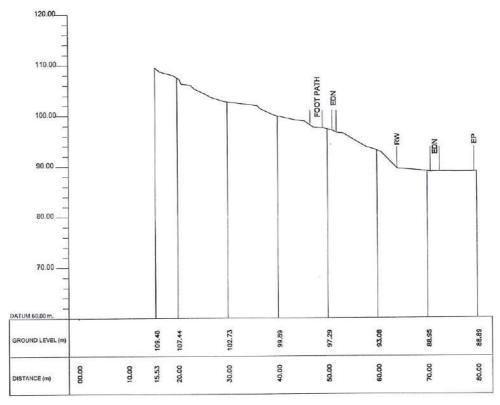

SECTION 07

EMPLOYER A

DEMOCRATIC SOCIALIST REPUBLIC OF SRI LANKA
STATE MINISTRY OF INTERNAL SECURITY, HOME AFFAIRS
AND DISASTER MANAGEMENT
NATIONAL BUILDING RESEARCH ORGANISATION
No. 99/1 ,JAWATTA ROAD

COLOMBO - 05

DESIGNER


DESIGN UNIT
NATIONAL BUILDING RESEARCH ORGANISATION
No. 99/1 ,JAWATTA ROAD
COLOMBO - 05


REV DATE REVISION DESCRIPTION APPROVAL PROJECT TITLE


VULNERA

REDUCTION OF LANDSLIDE
VULNERABILITY BY MITIGATION MEASURES
POLGAHAWELA BUS STAND

| TITLE | | | | DESCRIPTION | NAME | SIGNATURE |
|-----------------------|-------|------|------------|---------------|------------------------|-----------|
| | | | | SURVEYED | LANKA G.P.S. (PVT) LTD | |
| SURVEY CROSS SECTIONS | | | CHECKED | B.I. KUMARAGE | | |
| | | | | | | |
| SCALE | 1:750 | DATE | 12.11.2020 | | | |
| PROJECT / DRAWING No. | | | REVISION | | | |

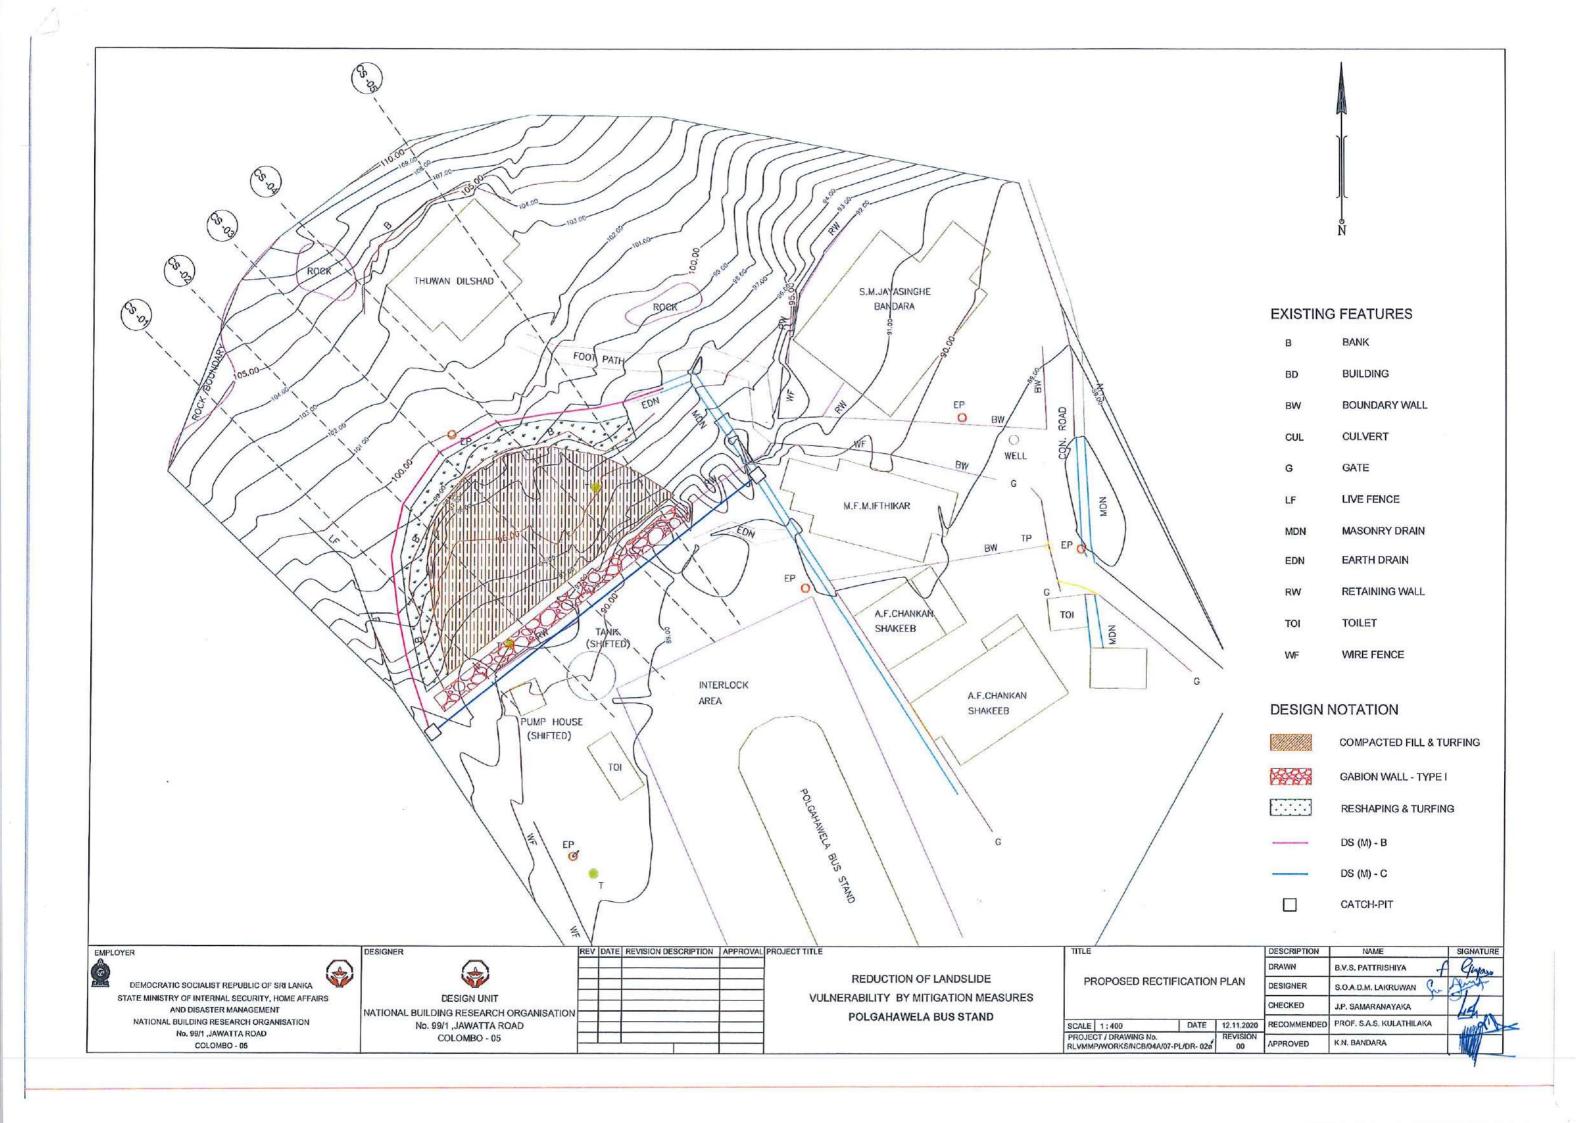

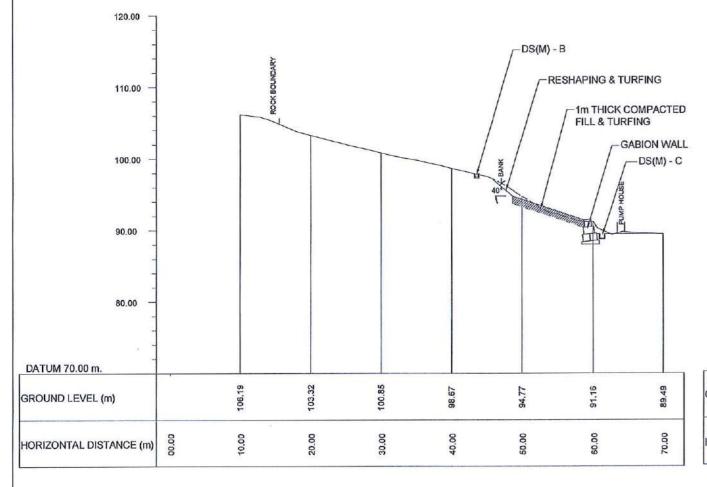

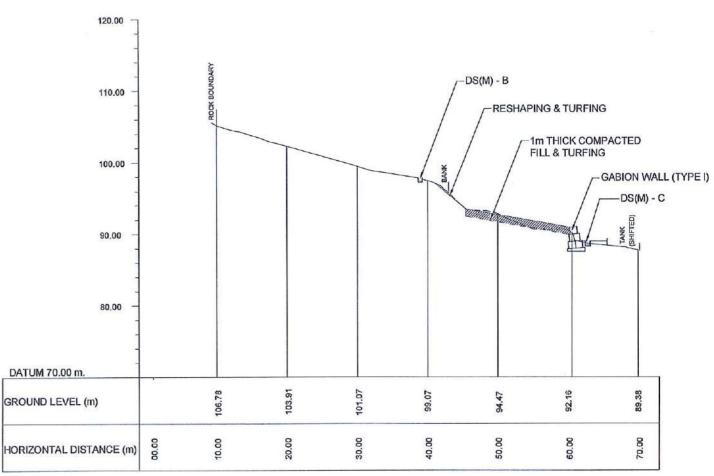

CS - 01

CS - 02

DEMOCRATIC SOCIALIST REPUBLIC OF SRI LANKA
STATE MINISTRY OF INTERNAL SECURITY, HOME AFFAIRS

AND DISASTER MANAGEMENT
NATIONAL BUILDING RESEARCH ORGANISATION
No. 99/1 "JAWATTA ROAD
COLOMBO - 05

DESIGNER

DESIGN UNIT

NATIONAL BUILDING RESEARCH ORGANISATION

No. 99/1 ,JAWATTA ROAD

COLOMBO - 05

REDUCTION OF LANDSLIDE
VULNERABILITY BY MITIGATION MEASURES
POLGAHAWELA BUS STAND

REV DATE REVISION DESCRIPTION APPROVAL PROJECT TITLE

DESIGN CROSS SECTIONS


DESIGN CROSS SECTIONS


DESIGNER

DESIGN CROSS SECTIONS

DESIGNER

DESIGNE

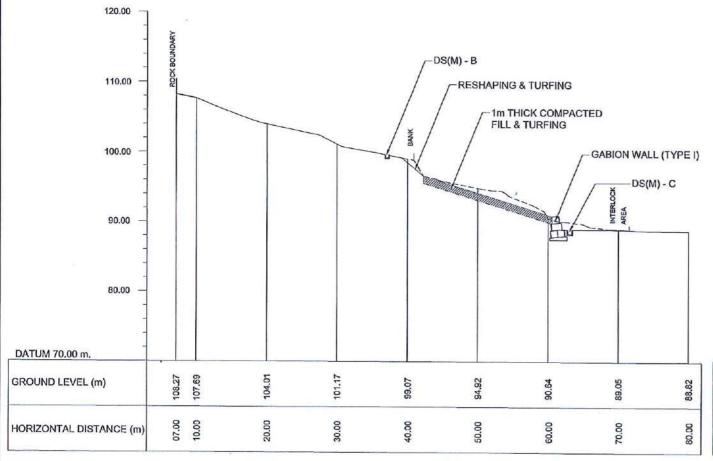

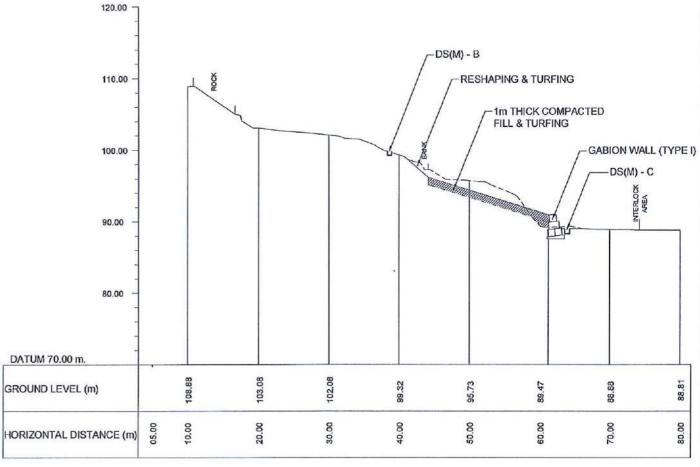

CS - 03

CS - 04

EMPLOYER

DEMOCRATIC SOCIALIST REPUBLIC OF SRI LANKA STATE MINISTRY OF INTERNAL SECURITY, HOME AFFAIRS AND DISASTER MANAGEMENT NATIONAL BUILDING RESEARCH ORGANISATION No. 99/1 ,JAWATTA ROAD


COLOMBO - 05

DESIGN UNIT NATIONAL BUILDING RESEARCH ORGANISATION No. 99/1 ,JAWATTA ROAD COLOMBO - 05

REV DATE REVISION DESCRIPTION | APPROVAL PROJECT TITLE

REDUCTION OF LANDSLIDE VULNERABILITY BY MITIGATION MEASURES POLGAHAWELA BUS STAND

| | TITLE | TLE | | | DESCRIPTION | NAME | SIGNATURE | |
|--|---|-------|------|----------------|-------------|--------------------------|-----------|--|
| | DESIGN CROSS SECTIONS | | | | DRAWN | B.V.S. PATTRISHIYA & | Grova | |
| | | | | | DESIGNER | S.O.A.D.M. LAKRUWAN | Augh. | |
| | | | | | CHECKED | J.P. SAMARANAYAKA | Id. | |
| | SCALE | 1:500 | DATE | 12.11.2020 | RECOMMENDED | PROF. S.A.S. KULATHILAKA | - Makel | |
| | PROJECT / DRAWING No. RLVMMP/WORKS/NCB/04A/07-PL/DR- 02c | | | REVISION 00 | APPROVED | K.N. BANDARA | | |

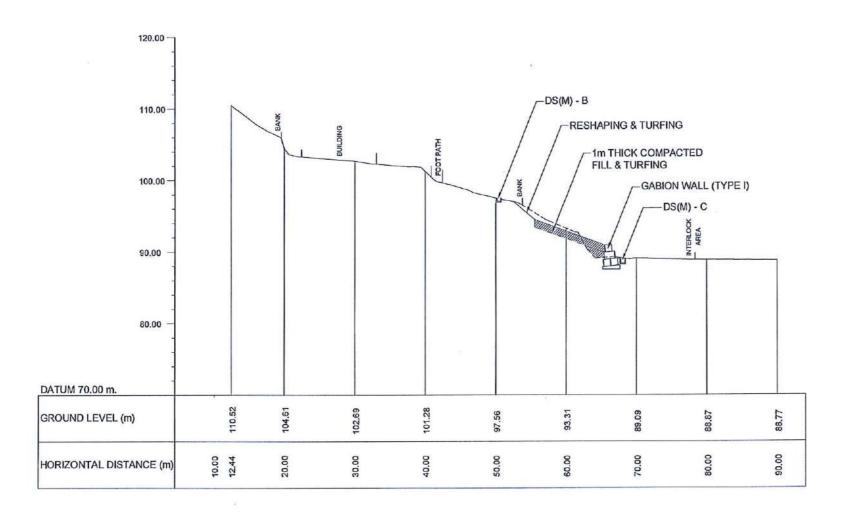

CS - 05



DEMOCRATIC SOCIALIST REPUBLIC OF SRI LANKA
STATE MINISTRY OF INTERNAL SECURITY, HOME AFFAIRS
AND DISASTER MANAGEMENT
NATIONAL BUILDING RESEARCH ORGANISATION
No. 99/1 ,JAWATTA ROAD
COLOMBO - 05

DESIGNER

DESIGN UNIT

NATIONAL BUILDING RESEARCH ORGANISATION

No. 99/1 ,JAWATTA ROAD

COLOMBO - 05

\


REV DATE REVISION DESCRIPTION | APPROVAL PROJECT TITLE

REDUCTION OF LANDSLIDE


VULNERABILITY BY MITIGATION MEASURES


POLGAHAWELA BUS STAND

| TITLE | TITLE | | | DESCRIPTION | NAME | SIGNATURE |
|-------|-----------------------------|-----------|----|-------------|--------------------------|-----------|
| | | | | DRAWN | B.V.S. PATTRISHIYA | Crays |
| | DESIGN CRO | SS SECTIO | NS | DESIGNER | S.O.A.D.M. LAKRUWAN | and the |
| | SCALE 1:500 DATE 12:1 | | | CHECKED J.F | J.P. SAMARANAYAKA | 14 |
| SCALE | | | | RECOMMENDED | PROF. S.A.S. KULATHILAKA | al lunch |
| | | | | APPROVED | K.N. BANDARA | |

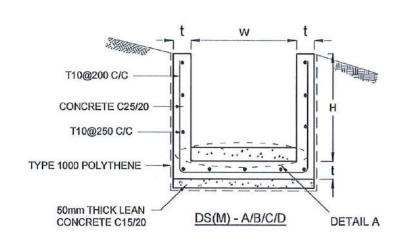

| DRAIN TYPE | W (mm) | H (mm) | t (mm) |
|---------------|--------|--------|--------|
| DS (M) - A /P | 300 | 300 | 100 |
| DS (M) - B/R | 450 | 450 | 100 |
| DS (M) - C/Q | 600 | 600 | 100 |
| DS (M) - D | 750 | 750 | 125 |
| DS (M) - E | 900 | 900 | 150 |
| DS (M) - F | 1000 | 1000 | 150 |

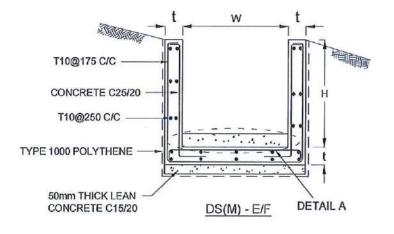

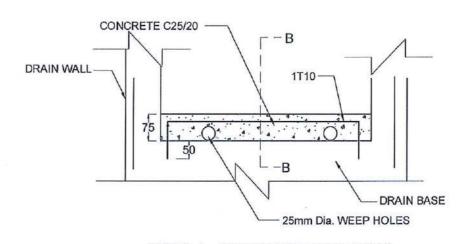

DETAIL A - (ENERGY BREAKER AT 3M)

NOTES


- DEPTH OF EXCAVATION MAY VARY ACCORDING TO SITE CONDITIONS.
- STEPS SHALL BE CONSTRUCTED AT SURFACE DRAIN ON SLOPING GROUND ACCORDING TO THE SITE CONDITIONS AS INSTRUCTED BY THE ENGINEER.
- ENERGY BREAKERS SHALL BE CONSTRUCTED AT THE STEEP DRAIN SEGMENTS AS PER THE INSTRUCTIONS OF THE ENGINEER.
- DOWELS SHALL BE INSTALLED ACCORDING TO THE GROUND CONDITIONS AS INSTRUCTED BY THE ENGINEER.
- 5. ALL DIMENSIONS ARE IN MILLIMETERS UNLESS OTHERWISE STATED.
- 10 mm THICK EXPANSION JOINT SHALL BE INTRODUCED IN EVERY 5m INTERVAL.


CONCRETE


- 7. USE FOLLOWING CONCRETE GRADES FOR STRUCTURE
 - [a] SCREED C. 15/20
 - [b] WALLS / BASE / ENERGY BREAKERS C. 25/20

REINFORCEMENT

- ALL BARS MARKED "T" SHALL BE HIGH YIELD DEFORMED BARS OF YIELD STRENGTH NOT LESS THAN 460N/mm².
- BARS OF CUT LENGTH LARGER THAN THE SUPPLIED LENGTH TO BE LAPPED FOR A LENGTH OF 50 x BAR DIA. AND LAPPING SHOULD BE STAGGERED.
- 10. ANCHORAGE LENGTH SHOULD BE 40X BAR DIA.
- REINFORCEMENT BARS SHALL BE BENT IN ACCORDANCE WITH STANDARD SPECIFICATIONS.
- 12. COVER TO REINFORCEMENT
 - [a] BURIED FACES AND DRAIN INVERTS 40 mm
 [b] ALL OTHER FACES 25 mm

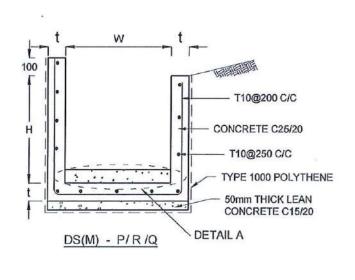


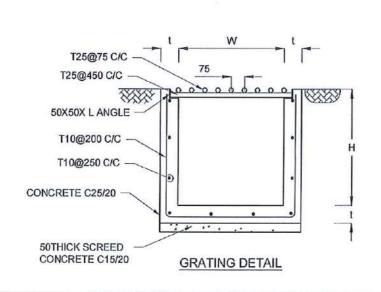

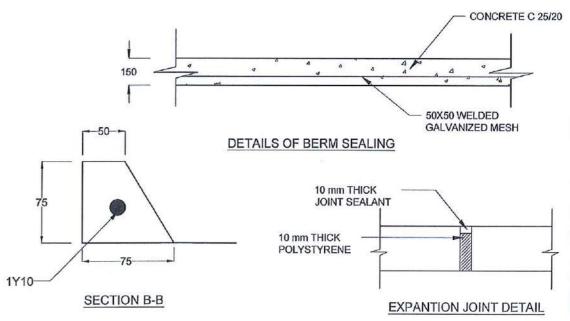





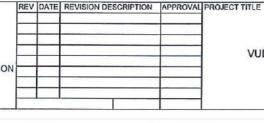

REDUCTION OF LANDSLIDE

VULNERABILITY BY MITIGATION MEASURES

POLGAHAWELA BUS STAND

DETAILS OF DRAINS (SURFACE DRAIN -1 OF 2)

SCALE N.T.S.

PROJECT / DRAWING No


RLVMMP/WORKS/NCB/04A/07-PL/DR- 03a


DESCRIPTION NAME SIGNATURE
DRAWN B.V.S. PATTRISHIYA F GAYL

DESIGNER S.O.A.D.M. LAKRUWAN CHECKED J.P. SAMARANAYAKA

DATE 12.11.2020 RECOMMENDED PROF. S.A.S. KULATHILAKA

REVISION DO APPROVED K.N. BANDARA

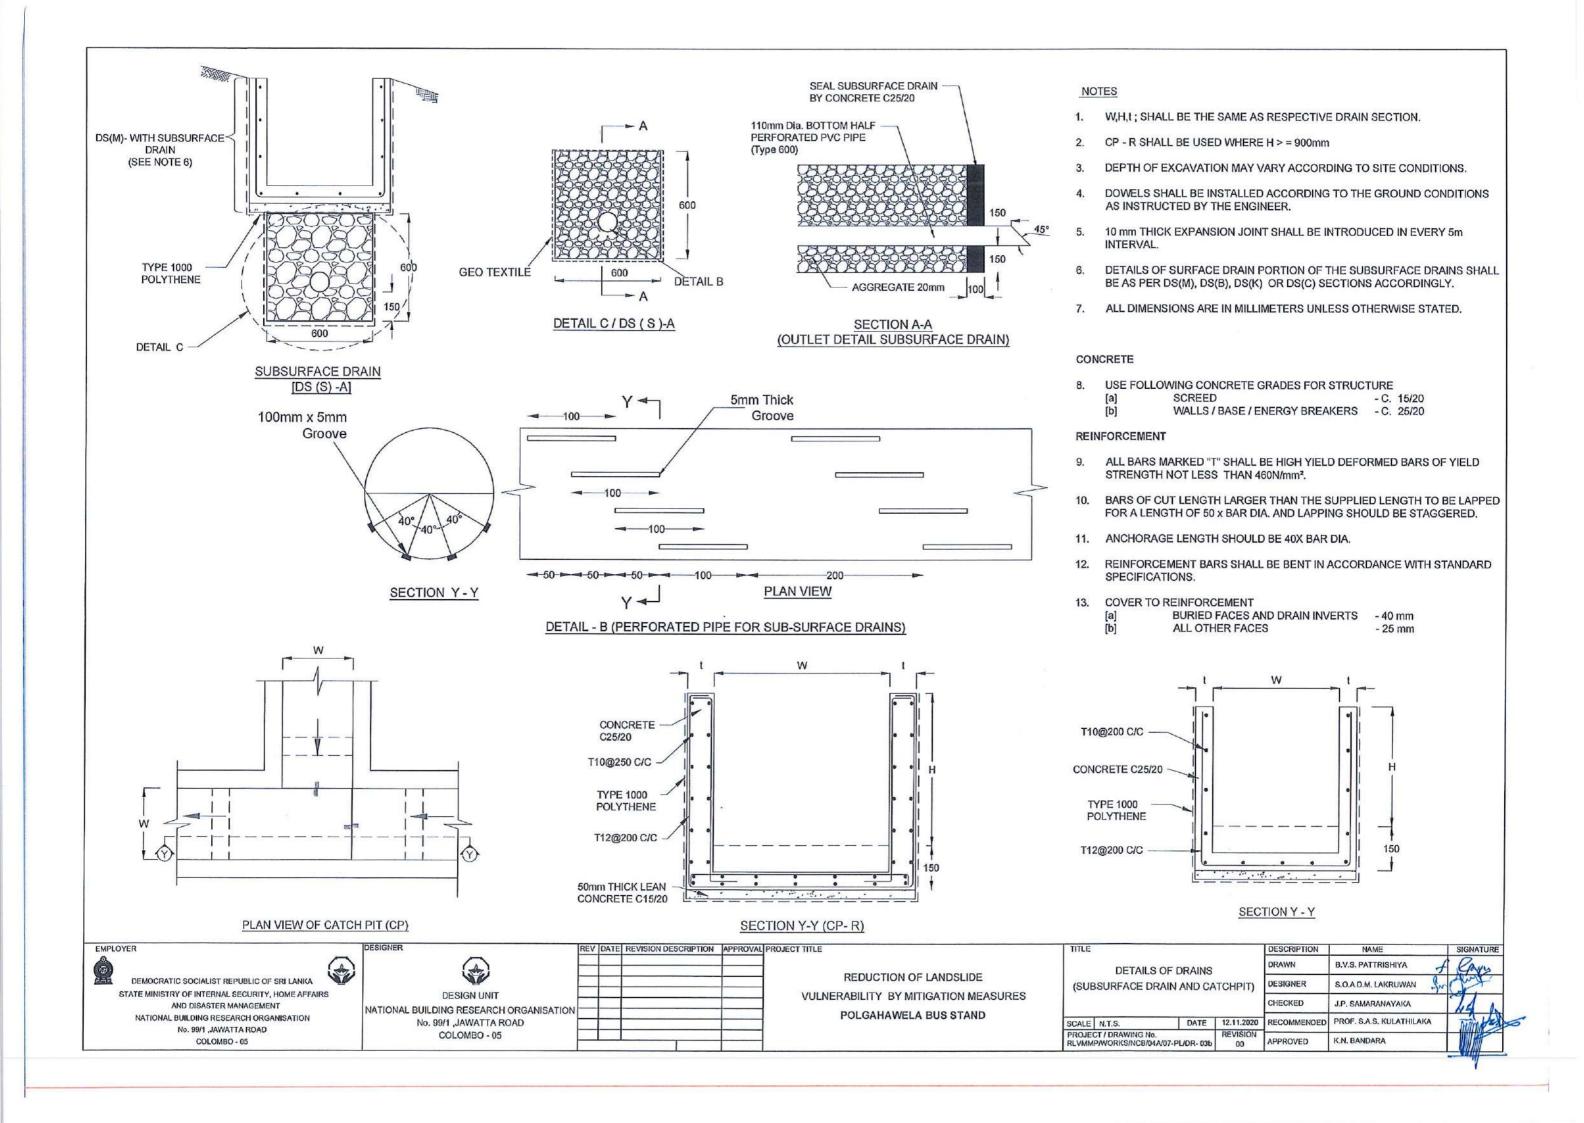

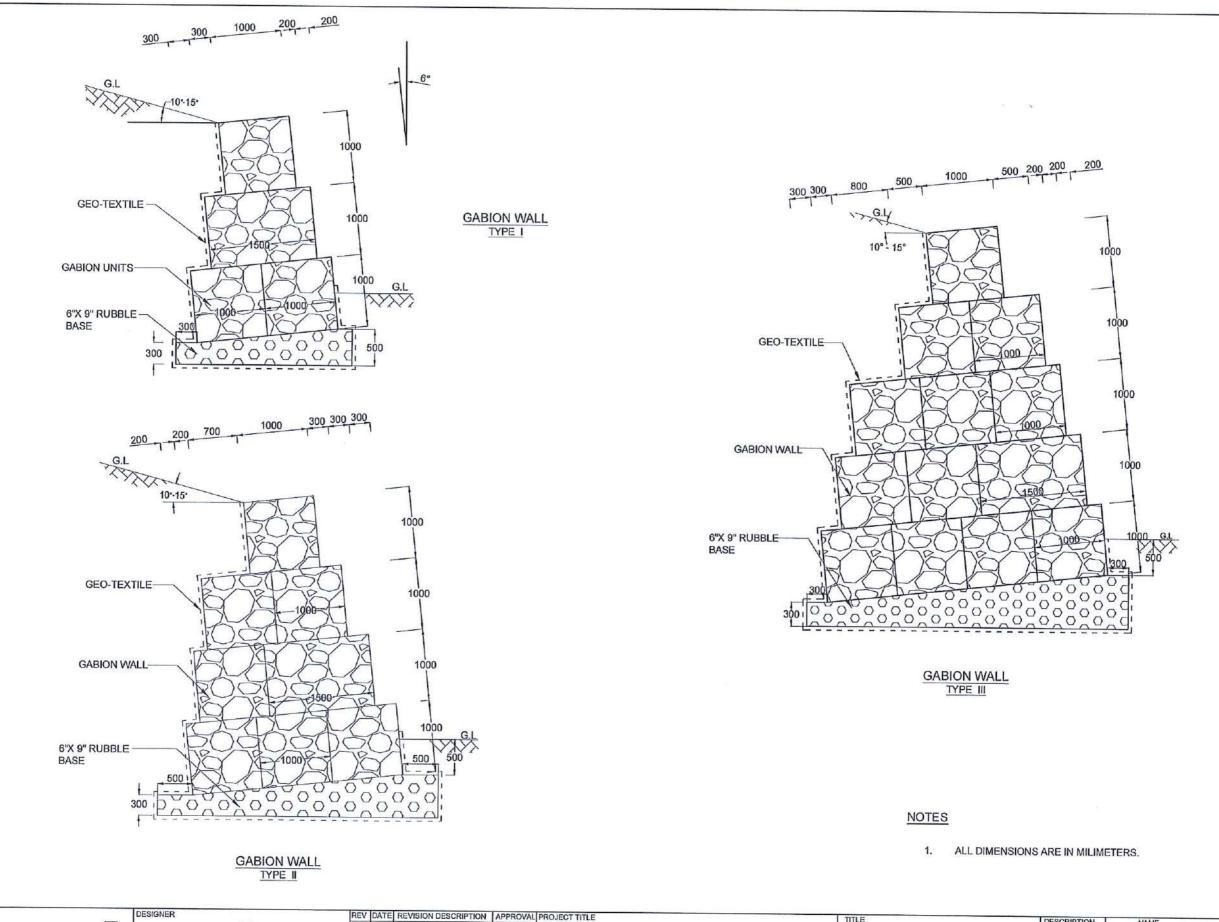

EMPLOYER

DEMOCRATIC SOCIALIST REPUBLIC OF SRI LANKA
STATE MINISTRY OF INTERNAL SECURITY, HOME AFFAIRS
AND DISASTER MANAGEMENT
NATIONAL BUILDING RESEARCH ORGANISATION
No. 99/1 JAWATTA ROAD
COLOMBO - 05

DESIGN UNIT

NATIONAL BUILDING RESEARCH ORGANISATION


No. 99/1 ,JAWATTA ROAD

COLOMBO - 05

REDUCTION OF LANDSLIDE
VULNERABILITY BY MITIGATION MEASURES
POLGAHAWELA BUS STAND

| NTLE | | | | DESCRIPTION | NAME | SIGNATURE | |
|--|--------------------------|--|------------|-------------|--------------------------|-----------|--|
| | | | | DRAWN | B.V.S. PATTRISHIYA | | |
| DETAILS OF GABION WALL | | | ALL | DESIGNER | S.O.A.D.M. LAKRUWAN | or Just | |
| | | | | CHECKED | J.P. SAMARANAYAKA | Id. | |
| | LE N.T.S. DATE 12.11.202 | | 12.11,2020 | RECOMMENDED | PROF. S.A.S. KULATHILAKA | A SULLAND | |
| ROJECT / DRAWING No. LVMMP/WORKS/NCB/04A/07-PL/DR- 04 REVISION 00 | | | | APPROVED | K.N. BANDARA | Will | |

LEVEL PLAN NO: 2017/L/Kegalle/LRRMD-23

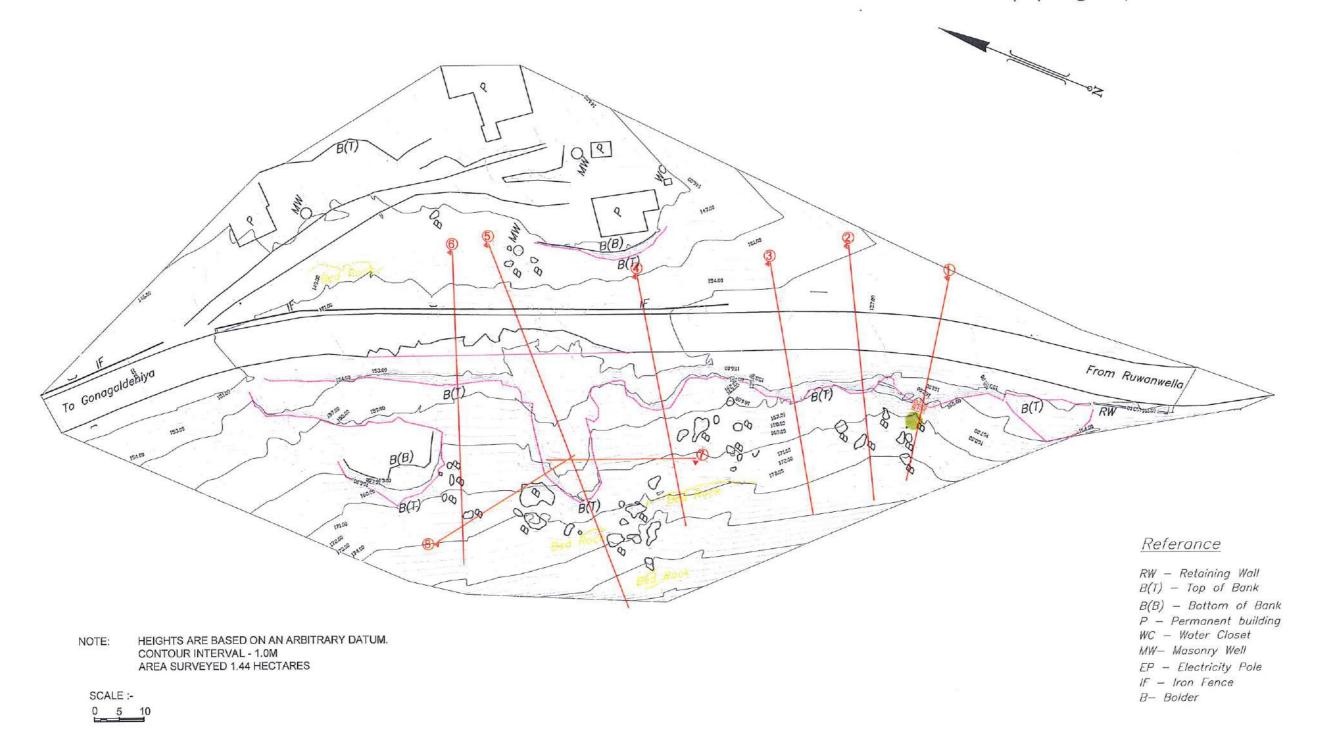

EMPLOYER


DEMOCRATIC SOCIALIST REPUBLIC OF SRI LANKA STATE MINISTRY OF INTERNAL SECURITY, HOME AFFAIRS AND DISASTER MANAGEMENT NATIONAL BUILDING RESEARCH ORGANIZATION No. 99/1 ,JAWATTA ROAD COLOMBO - 05


| DESIGNER | |
|------------|--------------|
| | |
| | DESIGN |
| IATIONAL B | UILDING RESE |

| DESIGN UNIT | |
|--|---|
| ATIONAL BUILDING RESEARCH ORGANIZATION | ٨ |
| No. 99/1 ,JAWATTA ROAD | |
| COLOMBO - 05 | |
| | |

| ſ | DATE | REVISION DESCRIPTION | APPROVAL | PROJECT TITLE |
|---|------|----------------------|----------|--|
| | | | | REDUCTION OF LANDSLIDE VULNERABILITY |
| | | | | BY MITIGATION MEASURES |
| | | | | VEYANGODA-RUWANWELLA ROAD (B445) - |
| | | | | LOCATION 01 (CH. 23+100 - CH 23+210 RHS) |
| | 1 | | 1 | W |


| TITLE | Ε | | | DESCRIPTION | NAME | SIGNATURE |
|---|-------|------|----------------|---------------------------|-------------------|-----------|
| | | | | SURVEYED KAMAL DESHAPRIYA | | |
| CONTOUR SURVEY PLAN | | | | CHECKED | M. H. M. HARSHANI | |
| | | | | | | |
| SCALE | 1:750 | DATE | 05.11.2020 | | | |
| PROJECT / DRAWING No. REVISIO RLVMMP/WORKS/NCB/04A/25-Ru/DR - 01 00 | | | REVISION 00 | | | |

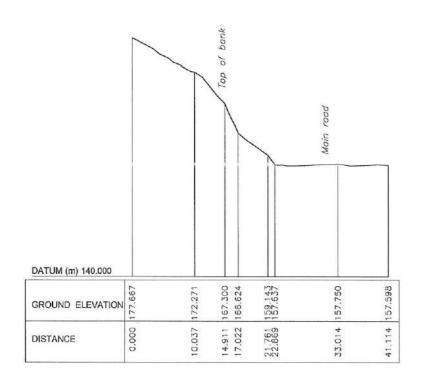

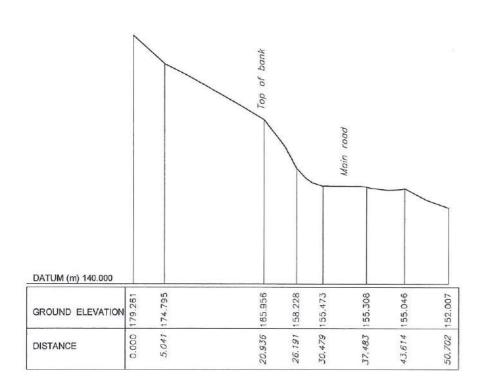


SECTION-3

DESIGNER

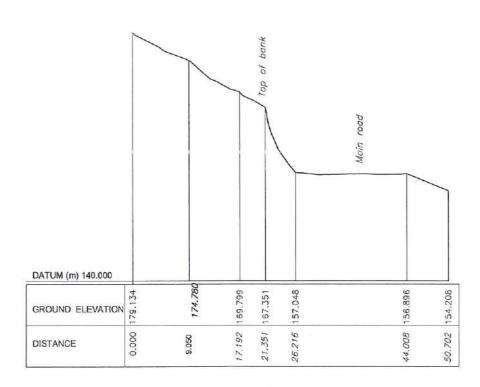

SECTION-2

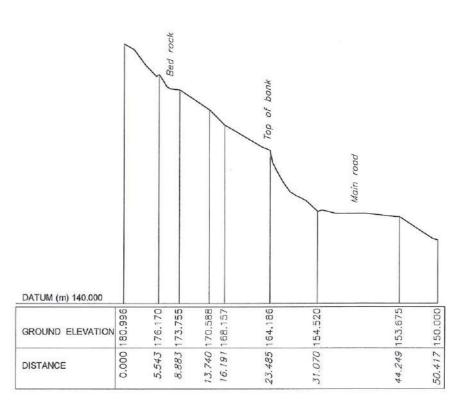

SECTION-4


| MPLOYE | R |
|--------|--|
| å | |
| 2 | DEMOCRATIC SOCIALIST REPUBLIC OF SRI LANKA |
| ST | TATE MINISTRY OF INTERNAL SECURITY, HOME AFFAIRS |
| | AND DISASTER MANAGEMENT |
| | NATIONAL BUILDING RESEARCH ORGANIZATION |
| | No 99/1 JAWATTA POAD |


COLOMBO - 05

| NIZATION |
|----------|
| |
| |
| |


| ·V | DATE | REVISION DESCRIPTION | APPROVAL | PROJECT TILE |
|----|------|----------------------|----------|--|
| | | | | REDUCTION OF LANDSLIDE VULNERABILITY |
| | | | | BY MITIGATION MEASURES |
| | | | | VEYANGODA-RUWANWELLA ROAD (B445) - |
| | | | | LOCATION 01 (CH. 23+100 - CH 23+210 RHS) |

| TITLE | | | | DESCRIPTION | NAME | SIGNATURE |
|--|-----------------------|------|------------|-------------|-------------------|-----------|
| | | | | SURVEYED | KAMAL DESHAPRIYA | |
| | SURVEY CROSS SECTIONS | | | CHECKED | M. H. M. HARSHANI | |
| | | | | | 14 | |
| SCALE | 1:750 | DATE | 05.11.2020 | | | |
| PROJECT / DRAWING No. REVISION RLVMMP/WORKS/NCB/04A/25-Ru/DR - 02a 00 | | | | | | |

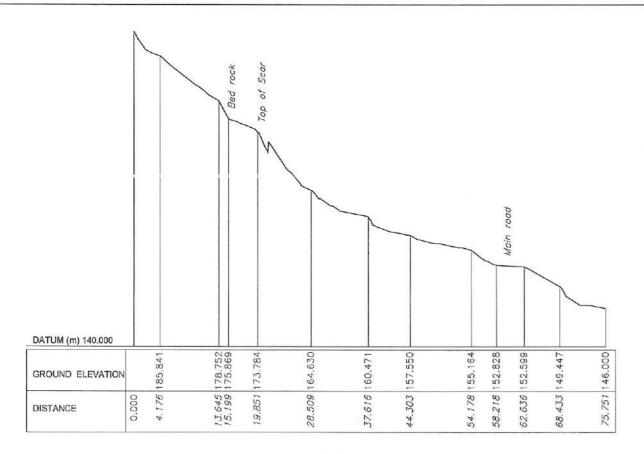


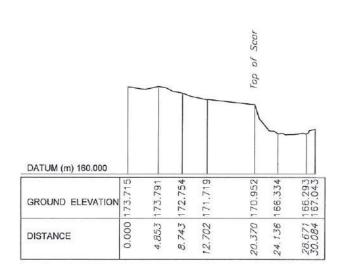

SECTION-7

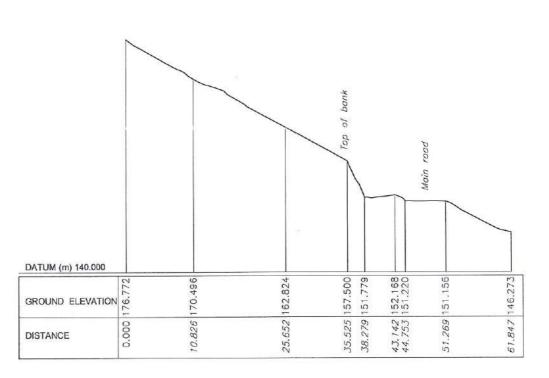

SECTION-6

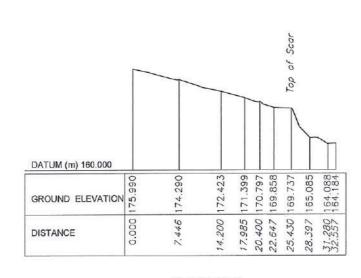


SECTION-8


| EMPLOYER | DESIGNER |
|--|--------------|
| DEMOCRATIC SOCIALIST REPUBLIC OF SRI LANKA STATE MINISTRY OF INTERNAL SECURITY, HOME AFFAIRS | |
| AND DISASTER MANAGEMENT | NATIONAL E |
| NATIONAL BUILDING RESEARCH ORGANIZATION | TO THOM IS I |
| No. 99/1 ,JAWATTA ROAD | |
| COLOMBO - 05 | |


| DESIGN UNIT |
|---|
| NATIONAL BUILDING RESEARCH ORGANIZATION |
| No. 99/1 ,JAWATTA ROAD |
| COLOMBO - 05 |
| |

| | REV | DATE | REVISION DESCRIPTION | APPROVAL | PROJECT TITLE |
|---|-----|------|----------------------|----------|--|
| | | | | | REDUCTION OF LANDSLIDE VULNERABILITY |
| | | | * | | BY MITIGATION MEASURES |
| 1 | | | | | VEYANGODA-RUWANWELLA ROAD (B445) - |
| | | | | | LOCATION 01 (CH. 23+100 - CH 23+210 RHS) |

| TITLE | | | | DESCRIPTION | NAME | SIGNATURE |
|-------|--------------------------------------|----------------|----------------|-------------|-------------------|-----------|
| | | | | SURVEYED | KAMAL DESHAPRIYA | |
| | SURVEY CRO | SS SECTIO | ONS | CHECKED | M. H. M. HARSHANI | |
| 1 | · | la.m | | | | - |
| CALE | 1:750 | DATE | 05.11.2020 | | | |
| | T / DRAWING No. P/WORKS/NCB/04A/2 | 25-Ru/DR - 02b | REVISION 00 | | | |

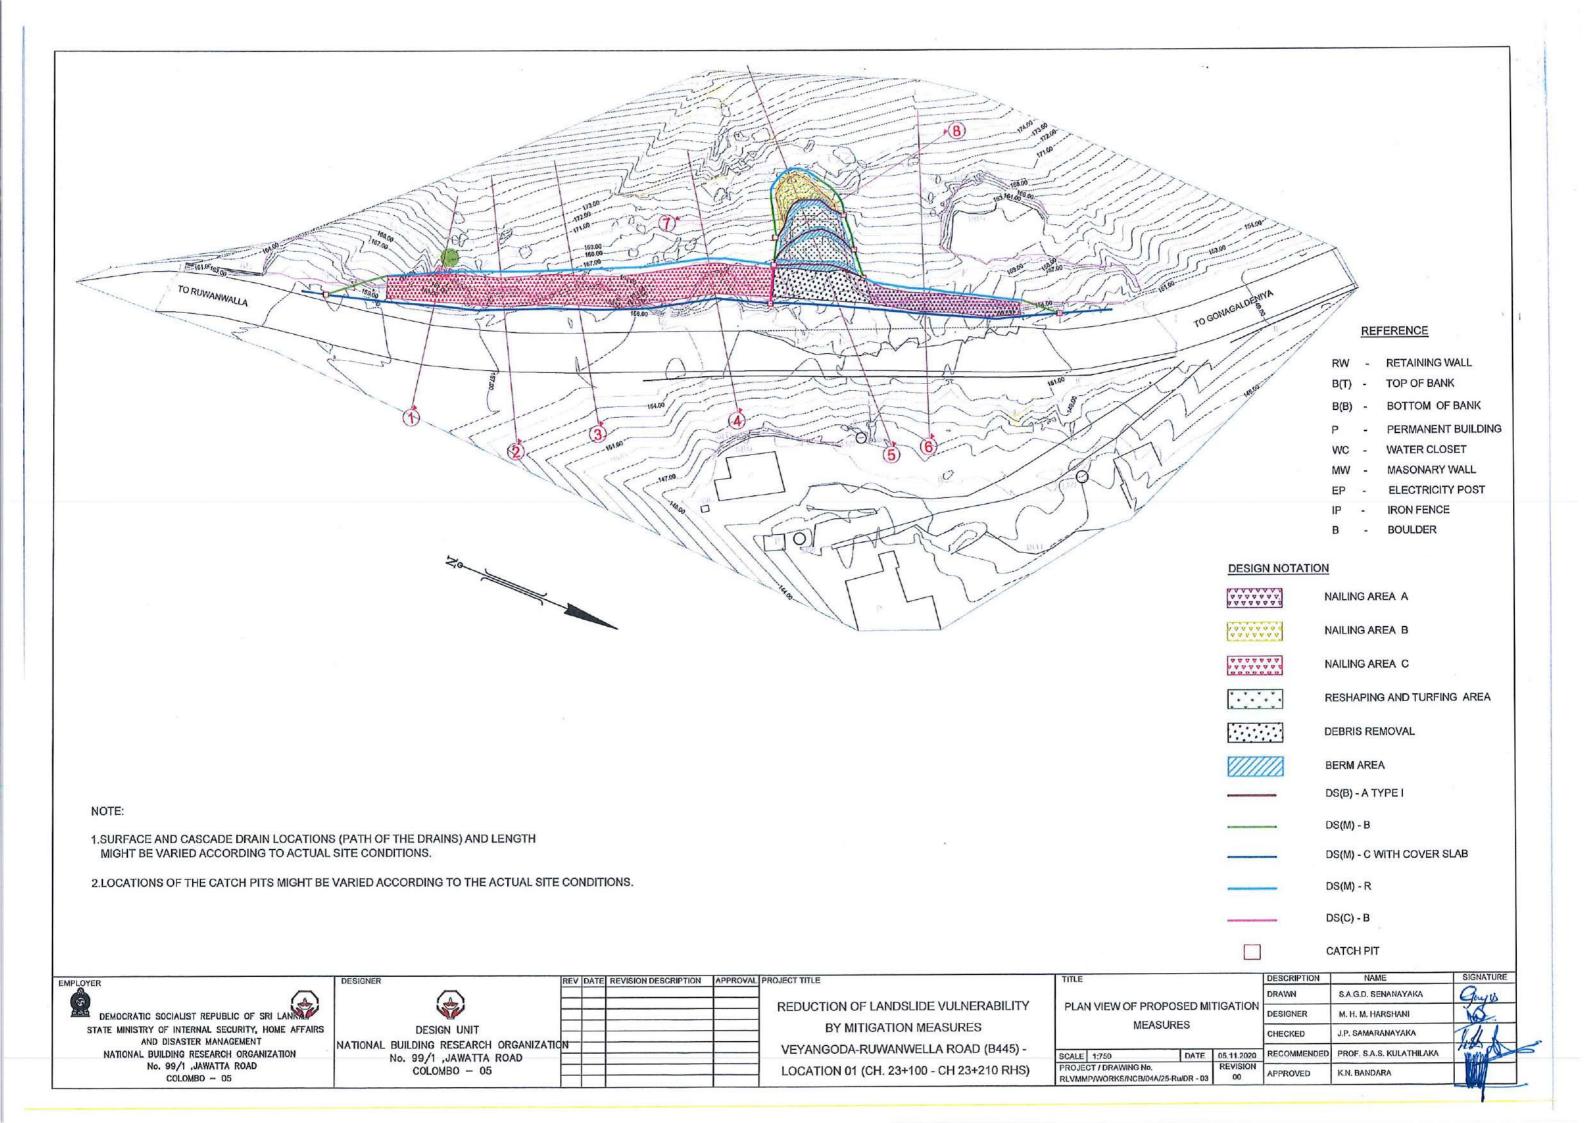

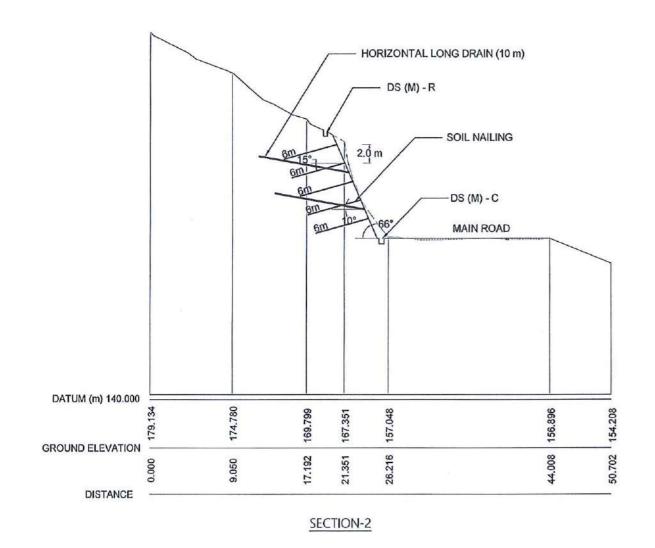

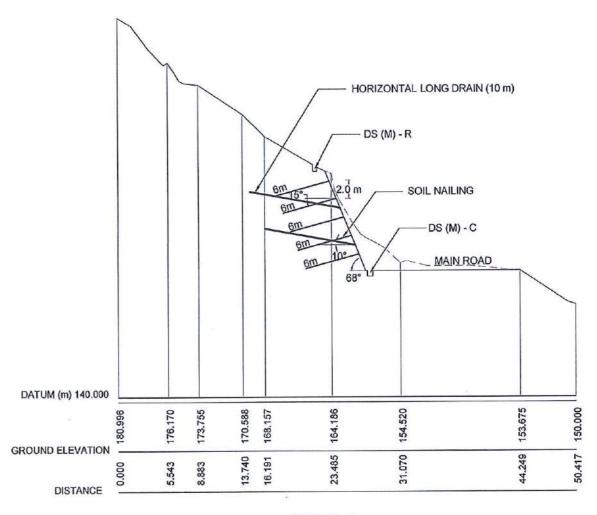

DEMOCRATIC SOCIALIST REPUBLIC OF SRI LANKA

STATE MINISTRY OF INTERNAL SECURITY, HOME AFFAIRS
AND DISASTER MANAGEMENT
NATIONAL BUILDING RESEARCH ORGANIZATION
No. 99/1 ,JAWATTA ROAD
COLOMBO - 05

DESIGNER

DESIGN UNIT

NATIONAL BUILDING RESEARCH ORG


No. 99/1 ,JAWATTA ROAD


COLOMBO - 05

| | REV | DATE | REVISION DESCRIPTION | APPROVAL | PROJECT TITLE |
|------------------|-----|------|----------------------|----------|---------------|
| | | | | | REDUCTI |
| | | | | | E |
| RGANIZATION D | | | | | VEYANG |
| , | | | | | LOCATIO |

REDUCTION OF LANDSLIDE VULNERABILITY
BY MITIGATION MEASURES
VEYANGODA-RUWANWELLA ROAD (B445) LOCATION 01 (CH. 23+100 - CH 23+210 RHS)

| TITLE | | | | DESCRIPTION | NAME | SIGNATURE |
|-------|-----------------|--|----------------|-------------|--------------------------|-----------|
| | | | | DRAWN | S.A.G.D. SENANAYAKA | Gazis |
| 0 | ROSS SECTION | | | DESIGNER | M. H. M. HARSHANI | M |
| | MITIGATIO | ON MEASURE | S | CHECKED | J.P. SAMARANAYAKA | LAL |
| SCALE | 1:400 | DATE | 05,11,2020 | RECOMMENDED | PROF, S.A.S, KULATHILAKA | mund |
| | CT / DRAWING NO | The same of the sa | REVISION 00 | APPROVED | K.N. BANDARA | |

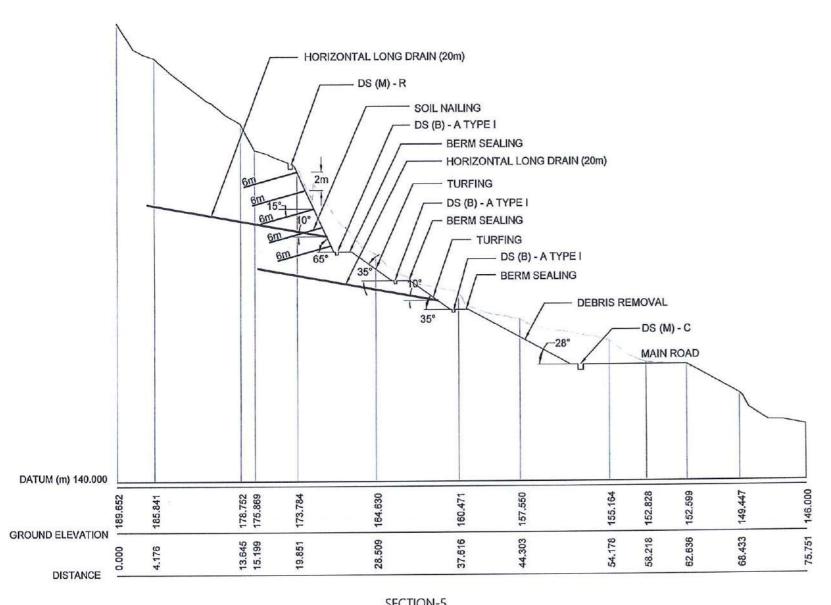

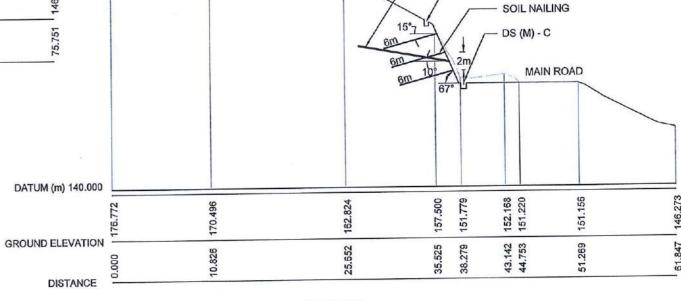

SECTION-6

EMPLOYER DEMOCRATIC SOCIALIST REPUBLIC OF SRI LANDIATE MINISTRY OF INTERNAL SECURITY STATE MINISTRY OF INTERNAL SECURITY, HOME AFFAIRS AND DISASTER MANAGEMENT NATIONAL BUILDING RESEARCH ORGANIZATION No. 99/1 ,JAWATTA ROAD COLOMBO - 05

DESIGNER **DESIGN UNIT** NATIONAL BUILDING RESEARCH ORGANIZATION No. 99/1 ,JAWATTA ROAD COLOMBO - 05


REV DATE REVISION DESCRIPTION | APPROVAL PROJECT TITLE


REDUCTION OF LANDSLIDE VULNERABILITY BY MITIGATION MEASURES VEYANGODA-RUWANWELLA ROAD (B445) -LOCATION 01 (CH. 23+100 - CH 23+210 RHS)

| TITLE | | | DESCRIPTION | NAME | SIGNATURE |
|--|-----------|----------------|-------------|--------------------------|-----------|
| | | | DRAWN | S.A.G.D. SENANAYAKA | · Gays |
| CROSS SECTIO | | | DESIGNER | M. H. M. HARSHANI | 100 |
| MITIGATIO | N MEASURE | S | CHECKED | J.P. SAMARANAYAKA | 4410 |
| SCALE 1:400 | DATE | 05.11.2020 | RECOMMENDED | PROF. S.A.S. KULATHILAKA | |
| PROJECT / DRAWING No. RLVMMP/WORKS/NCB/04 | | REVISION 00 | APPROVED | K.N. BANDARA | |

HORIZONTAL LONG DRAIN (10 m)

DS (M) - R

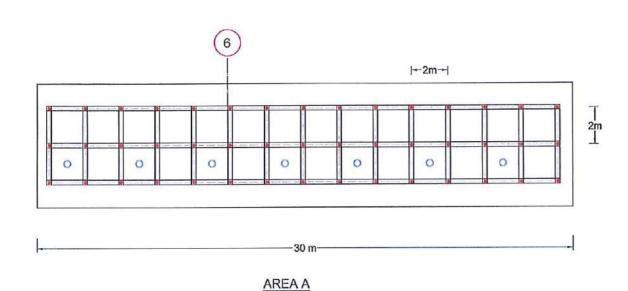

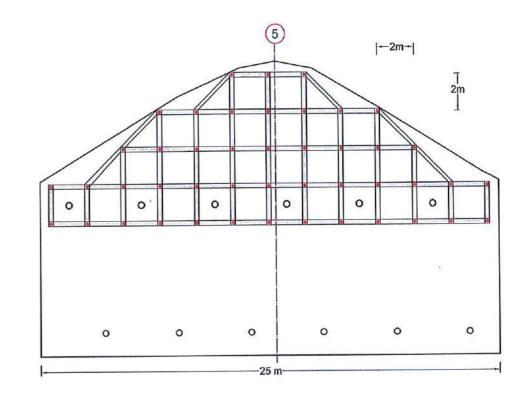

AREA B

LEGEND

SOIL NAILING -

TOTAL NAIL LENGTH= 6 m

NO'S OF NAIL = 45

REINFORCEMENT DIAMETER =32 mm
DIAMETER OF THE DRILLED HOLE =125 mm

NAIL SPACING = 2.0 m

O HORIZONTAL LONG DRAINAGE -

HORIZONTAL LONG DRAIN LENGTH =10 m

NO'S OF LONG DRAIN= 7

DIAMETER = 90 mm

LEGEND

SOIL NAILING -

TOTAL NAIL LENGTH= 6 m

NO'S OF NAIL = 45

REINFORCEMENT DIAMETER =32 mm DIAMETER OF THE DRILLED HOLE =125 mm

NAIL SPACING = 2.0 m

O HORIZONTAL LONG DRAINAGE -

HORIZONTAL LONG DRAIN LENGTH =20 m


NO'S OF LONG DRAIN= 12

DIAMETER = 90 mm

NOTES

LENGTH OF THE SOIL NAILS, LENGTH & LOCATION OF HORIZONTAL DRAINS
 MIGHT BE VARIED ACCORDING TO THE ACTUAL SOIL PROFILE OR SITE CONDITION.

DESCRIPTION NAME REV DATE REVISION DESCRIPTION | APPROVAL PROJECT TITLE DESIGNER EMPLOYER S.A.G.D. SENANAYAKA DRAWN FRONT ELEVATION OF PROPOSED DEMOCRATIC SOCIALIST REPUBLIC OF SRI LANK REDUCTION OF LANDSLIDE VULNERABILITY M. H. M. HARSHANI MITIGATION MEASURES BY MITIGATION MEASURES STATE MINISTRY OF INTERNAL SECURITY, HOME AFFAIRS DESIGN UNIT J.P. SAMARANAYAKA AREA A&B AND DISASTER MANAGEMENT NATIONAL BUILDING RESEARCH ORGANIZATION VEYANGODA-RUWANWELLA ROAD (B445) -RECOMMENDED PROF. S.A.S. KULATHILAKA DATE 05.11.2020 REVISION NATIONAL BUILDING RESEARCH ORGANIZATION SCALE 1:200 No. 99/1 ,JAWATTA ROAD No. 99/1 JAWATTA ROAD COLOMBO - 05 PROJECT / DRAWING No. COLOMBO - 05 LOCATION 01 (CH. 23+100 - CH 23+210 RHS) K.N. BANDARA APPROVED RLVMMP/WORKS/NCB/04A/25-Ru/DR - 05a

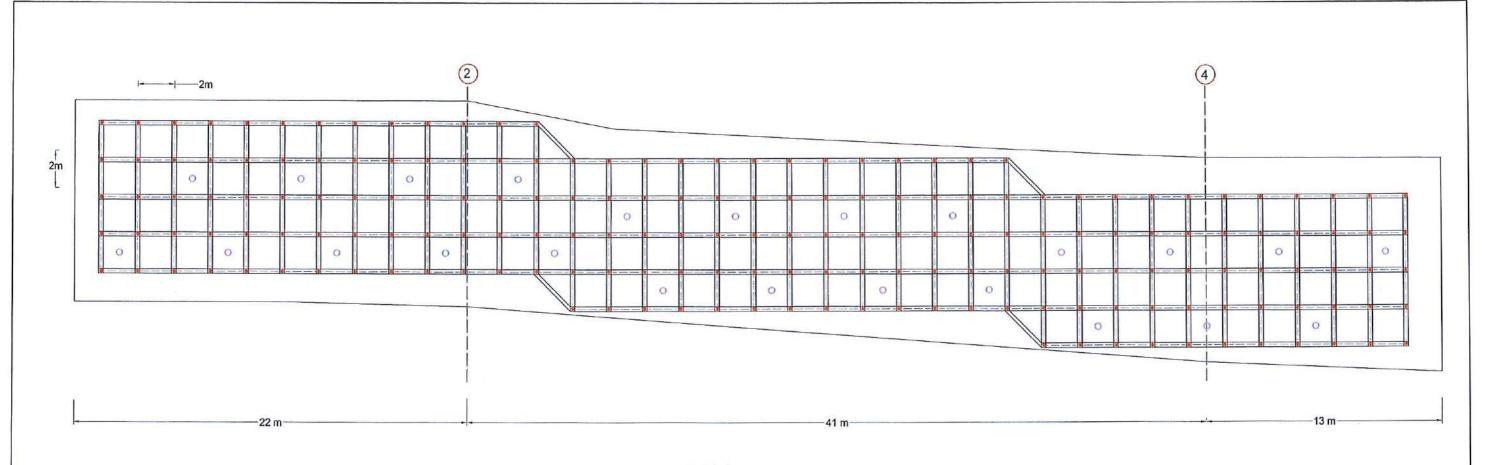

AREA C

LEGEND

SOIL NAILING -

TOTAL NAIL LENGTH= 6 m

NO'S OF NAIL = 185 REINFORCEMENT DIAMETER =32 mm

DIAMETER OF THE DRILLED HOLE =125 mm

NAIL SPACING = 2.0 m

O HORIZONTAL LONG DRAINAGE -

HORIZONTAL LONG DRAIN LENGTH =10 m NO'S OF LONG DRAIN = 24

DIAMETER = 90 mm

NOTES

LENGTH OF THE SOIL NAILS, LENGTH & LOCATION OF HORIZONTAL DRAINS
 MIGHT BE VARIED ACCORDING TO THE ACTUAL SOIL PROFILE OR SITE CONDITION.

EMPLOYER

DEMOCRATIC SOCIALIST REPUBLIC OF SRI LANKA
STATE MINISTRY OF INTERNAL SECURITY, HOME AFFAIRS
AND DISASTER MANAGEMENT
NATIONAL BUILDING RESEARCH ORGANIZATION
No. 99/1 "JAWATTA ROAD
COLOMBO - 05

| JESIGNER | (|
|----------|--------------|
| | DESIGN |
| ATIONAL | BUILDING RES |

DESIGN UNIT


TIONAL BUILDING RESEARCH ORGANIZATION

No. 99/1 "JAWATTA ROAD


COLOMBO - 05


| ΕV | DATE | REVISION DESCRIPTION | APPROVAL | PROJECT TITLE |
|----|------|----------------------|----------|--|
| | | | | REDUCTION OF LANDSLIDE VULNERABILITY |
| | | | | BY MITIGATION MEASURES |
| | | | | VEYANGODA-RUWANWELLA ROAD (B445) - |
| | | | | LOCATION 01 (CH. 23+100 - CH 23+210 RHS) |

| TITLE | | | | DESCRIPTION | NAME | SI |
|-------|------------------|---------------|------------|-------------|--------------------------|----|
| FR | ONT ELEVATI | ON OF PRO | POSED | DRAWN | S.A.G.D. SENANAYAKA | 1 |
| | MITIGATION | N MEASURE | ES | DESIGNER | M. H. M. HARSHANI | 1 |
| | AF | REA C | | CHECKED | J.P. SAMARANAYAKA | |
| SCALE | 1:200 | DATE | 05.11.2020 | RECOMMENDED | PROF. S.A.S. KULATHILAKA | |
| | CT / DRAWING No. | HOT D IDD 051 | REVISION | APPROVED | K.N. BANDARA | 7 |

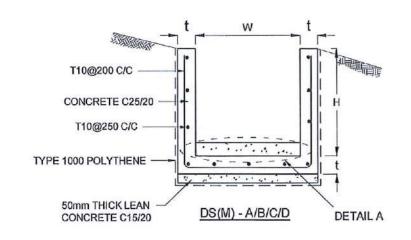



| DRAIN TYPE | W (mm) | H (mm) | t (mm) |
|---------------|--------|--------|--------|
| DS (M) - A /P | 300 | 300 | 100 |
| DS (M) - B/R | 450 | 450 | 100 |
| DS (M) - C/Q | 600 | 600 | 100 |
| DS (M) - D | 750 | 750 | 125 |
| DS (M) - E | 900 | 900 | 150 |
| DS (M) - F | 1000 | 1000 | 150 |

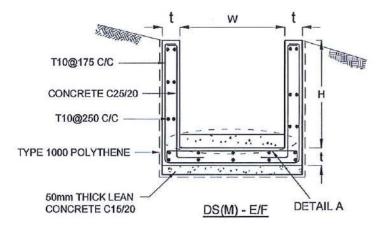


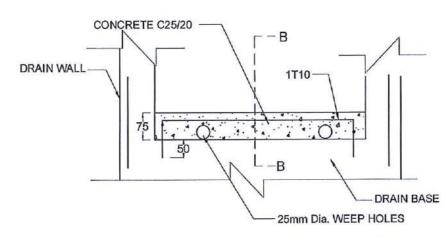

DETAIL A - (ENERGY BREAKER AT 3M)

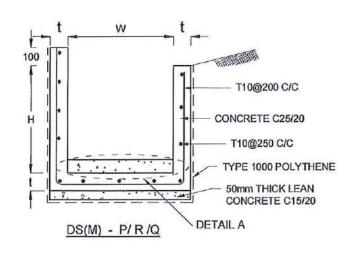


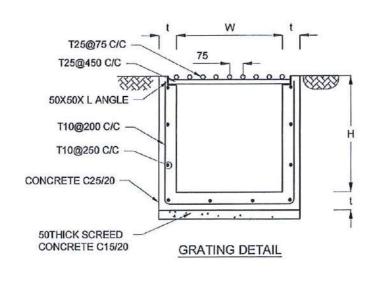

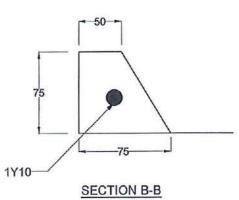

SCALE N.T.S.

PROJECT / DRAWING No

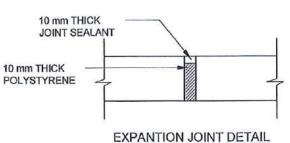

DEMOCRATIC SOCIALIST REPUBLIC OF SRI LANKA STATE MINISTRY OF INTERNAL SECURITY, HOME AFFAIRS AND DISASTER MANAGEMENT NATIONAL BUILDING RESEARCH ORGANIZATION No. 99/1, JAWATTA ROAD, COLOMBO - 05

EMPLOYER

DESIGN UNIT NATIONAL BUILDING RESEARCH ORGANIZATION No. 99/1, JAWATTA ROAD, COLOMBO - 05

DESIGNER

REVISION DESCRIPTION | APPROVAL PROJECT TITLE REDUCTION OF LANDSLIDE VULNERABILITY BY MITIGATION MEASURES VEYANGODA-RUWANWELLA ROAD (B445) -LOCATION 01 (CH. 23+100 - CH 23+210 RHS)

DETAILS OF DRAINS (SURFACE DRAIN -1 OF 2)

RLVMMP/WORKS/NCB/04A/25-Ru/DR - 06a-

DESCRIPTION SIGNATURE DRAWN S.A.G.D. SENANAYAKA DESIGNED CHECKED RECOMMENDED PROF. S.A.S. KULATHILAKA DATE 05.11.2020 REVISION APPROVED K.N. BANDARA 00

NOTES

- DEPTH OF EXCAVATION MAY VARY ACCORDING TO SITE CONDITIONS.
- STEPS SHALL BE CONSTRUCTED AT SURFACE DRAIN ON SLOPING GROUND ACCORDING TO THE SITE CONDITIONS AS INSTRUCTED BY THE ENGINEER.
- ENERGY BREAKERS SHALL BE CONSTRUCTED AT THE STEEP DRAIN SEGMENTS AS PER THE INSTRUCTIONS OF THE ENGINEER.
- DOWELS SHALL BE INSTALLED ACCORDING TO THE GROUND CONDITIONS AS INSTRUCTED BY THE ENGINEER.
- ALL DIMENSIONS ARE IN MILLIMETERS UNLESS OR OTHERWISE STATED.
- 10 mm THICK EXPANSION JOINT SHALL BE INTRODUCED IN EVERY 5m INTERVAL.


CONCRETE

7. USE FOLLOWING CONCRETE GRADES FOR STRUCTURE

[a] SCREED [b] WALLS / BASE / ENERGY BREAKERS - C. 25/20

REINFORCEMENT

- ALL BARS MARKED "T" SHALL BE HIGH YIELD DEFORMED BARS OF YIELD STRENGTH NOT LESS THAN 460N/mm².
- BARS OF CUT LENGTH LARGER THAN THE SUPPLIED LENGTH TO BE LAPPED FOR A LENGTH OF $50\,\mathrm{x}$ BAR DIA. AND LAPPING SHOULD BE
- ANCHORAGE LENGTH SHOULD BE 40X BAR DIA.
- REINFORCEMENT BARS SHALL BE BENT ACCORDANCE WITH STANDARD SPECIFICATIONS
- 14. COVER TO REINFORCEMENT
 - [a] BURIED FACES AND DRAIN INVERTS 40mm
 - ALL OTHER FACES

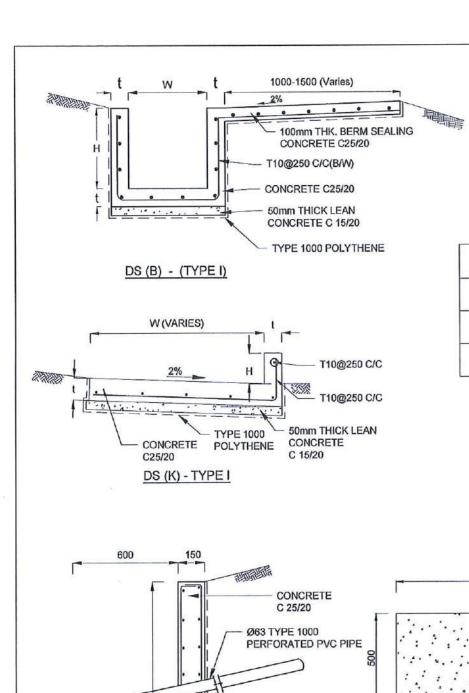

TYPE 1000

POLYTHENE


Ø50 WEEP HOLE

TYPE 1000 PVC

T10@250 C/C (BW)


C 15/20

50mm THICK LEAN CONCRETE

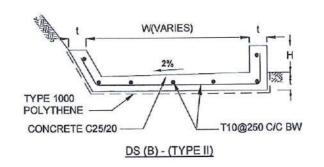


| DRAIN TYPE | W (mm) | H (mm) | t (mm) |
|------------|--------|--------|--------|
| DS (B) - A | 300 | 300 | 100 |
| DS (B) - B | 450 | 450 | 100 |
| DS (B) - C | 1000 | 150 | 100 |

| DRAIN TYPE | W (mm) | H (mm) | t (mm) |
|------------|--------|--------|--------|
| DS (K) - A | 1000 | 200 | 100 |
| DS (K) - B | 1000 | 300 | 100 |
| DS (K) - C | 1150 | 200 | 200 |

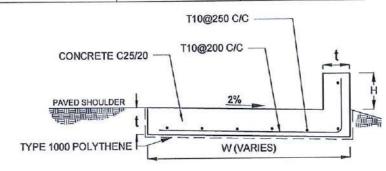

DS (K) - TYPE II

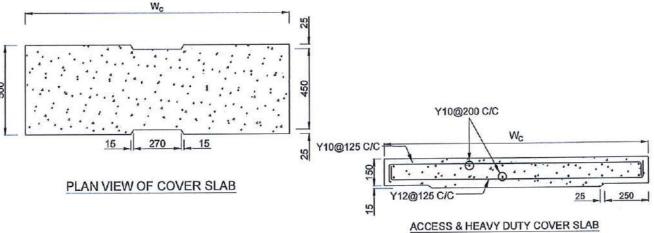

SECTION OF (W_C x 500 x 150mm)

| DS(M) - L | W (mm) | H' (mm) | t (mm) |
|-----------|--------|---------|--------|
| TYPE I | 600 | 600 | 150 |
| TYPE II | 800 | 800 | 150 |

NOTES

- DEPTH OF EXCAVATION MAY VARY ACCORDING TO SITE CONDITIONS.
- STEPS SHALL BE CONSTRUCTED AT SURFACE DRAIN ON SLOPING GROUND ACCORDING TO THE SITE CONDITIONS AS INSTRUCTED BY THE ENGINEER.
- ENERGY BREAKERS SHALL BE CONSTRUCTED AT THE STEEP DRAIN SEGMENTS AS PER THE INSTRUCTIONS OF THE ENGINEER.
- DOWELS SHALL BE INSTALLED ACCORDING TO THE GROUND CONDITIONS AS INSTRUCTED BY THE ENGINEER.
- COVER SLABS NEED TO BE PROVIDE ONLY FOR THE REGIONS AS INSTRUCTED BY THE ENGINEER.
- COVER SLAB WIDTH (W_C) SHOULD BE TAKEN AS THE SUM OF DRAIN WIDTH AND 2x DRAIN WALL THICKNESS. [Wc = W+2xt]
- 7. ALL DIMENSIONS ARE IN MILLIMETERS UNLESS OR OTHERWISE STATED.
- 10 mm THICK EXPANSION JOINT SHALL BE INTRODUCE IN EVERY 5m INTERVAL.

CONCRETE

- USE FOLLOWING CONCRETE GRADES FOR STRUCTURE
 - [b] WALLS / BASE / ENERGY BREAKERS C. 25/20

REINFORCEMENT

- ALL BARS MARKED "T" SHALL BE HIGH YIELD DEFORMED BARS OF YIELD STRENGTH NOT LESS THAN 460N/mm².
- BARS OF CUT LENGTH LARGER THAN THE SUPPLIED LENGTH TO BE LAPPED FOR A LENGTH OF 50 x BAR DIA. AND LAPPING SHOULD BE STAGGERED.
- 12. ANCHORAGE LENGTH SHOULD BE 40X BAR DIA.
- REINFORCEMENT BARS SHALL BE BENT ACCORDANCE WITH STANDARD SPECIFICATIONS.
- 14.
- COVER TO REINFORCEMENT
 [a] BURIED FACES AND DRAIN INVERTS 40mm
 [b] ALL OTHER FACES 25mm.

| DEMOC | CRATIC SOCIALIST REPUBLIC OF SRI LANK | A |
|-------|---------------------------------------|---|
| | VISTRY OF INTERNAL SECURITY, HOME AFF | |
| | AND DISASTER MANAGEMENT | |
| NATIO | ONAL BUILDING RESEARCH ORGANIZATION | 1 |
| | No. 99/1, JAWATTA ROAD, | |
| | COLOMBO DE | |

H (VARIES)

DS (M) - L

150


150


EMPLOYER


REVISION DESCRIPTION | APPROVAL PROJECT TITLE DESIGNER **DESIGN UNIT** NATIONAL BUILDING RESEARCH ORGANIZATION No. 99/1, JAWATTA ROAD, COLOMBO - 05


REDUCTION OF LANDSLIDE VULNERABILITY BY MITIGATION MEASURES VEYANGODA-RUWANWELLA ROAD (B445) -LOCATION 01 (CH. 23+100 - CH 23+210 RHS)


DESCRIPTION S.A.G.D. SENANAYAKA DRAWN **DETAILS OF DRAINS** (SURFACE DRAIN -2 OF 2) DESIGNED M. H. M. HARSHANI J.P. SAMARANAYAKA RECOMMENDED PROF. S.A.S. KULATHILAKA DATE 05.11.2020 SCALE N.T.S. REVISION PROJECT / DRAWING No. APPROVED K.N. BANDARA RLVMMP/WORKS/NCB/04A/25-Ru/DR - 06a-li

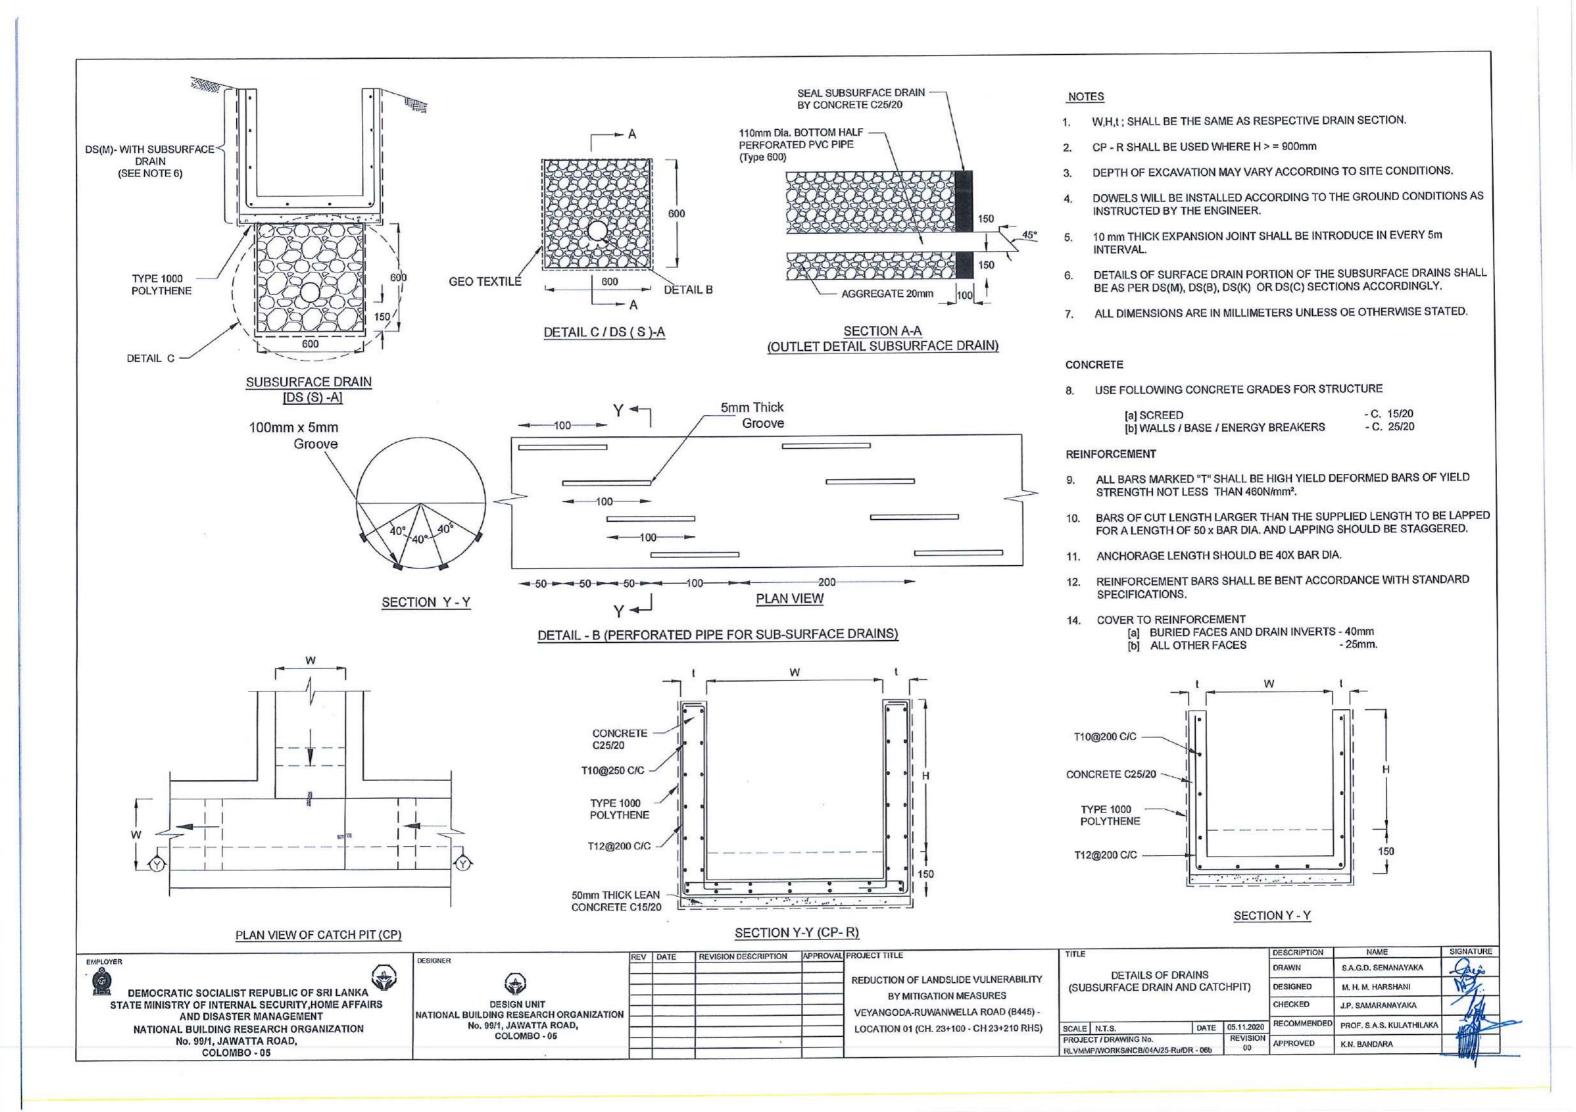


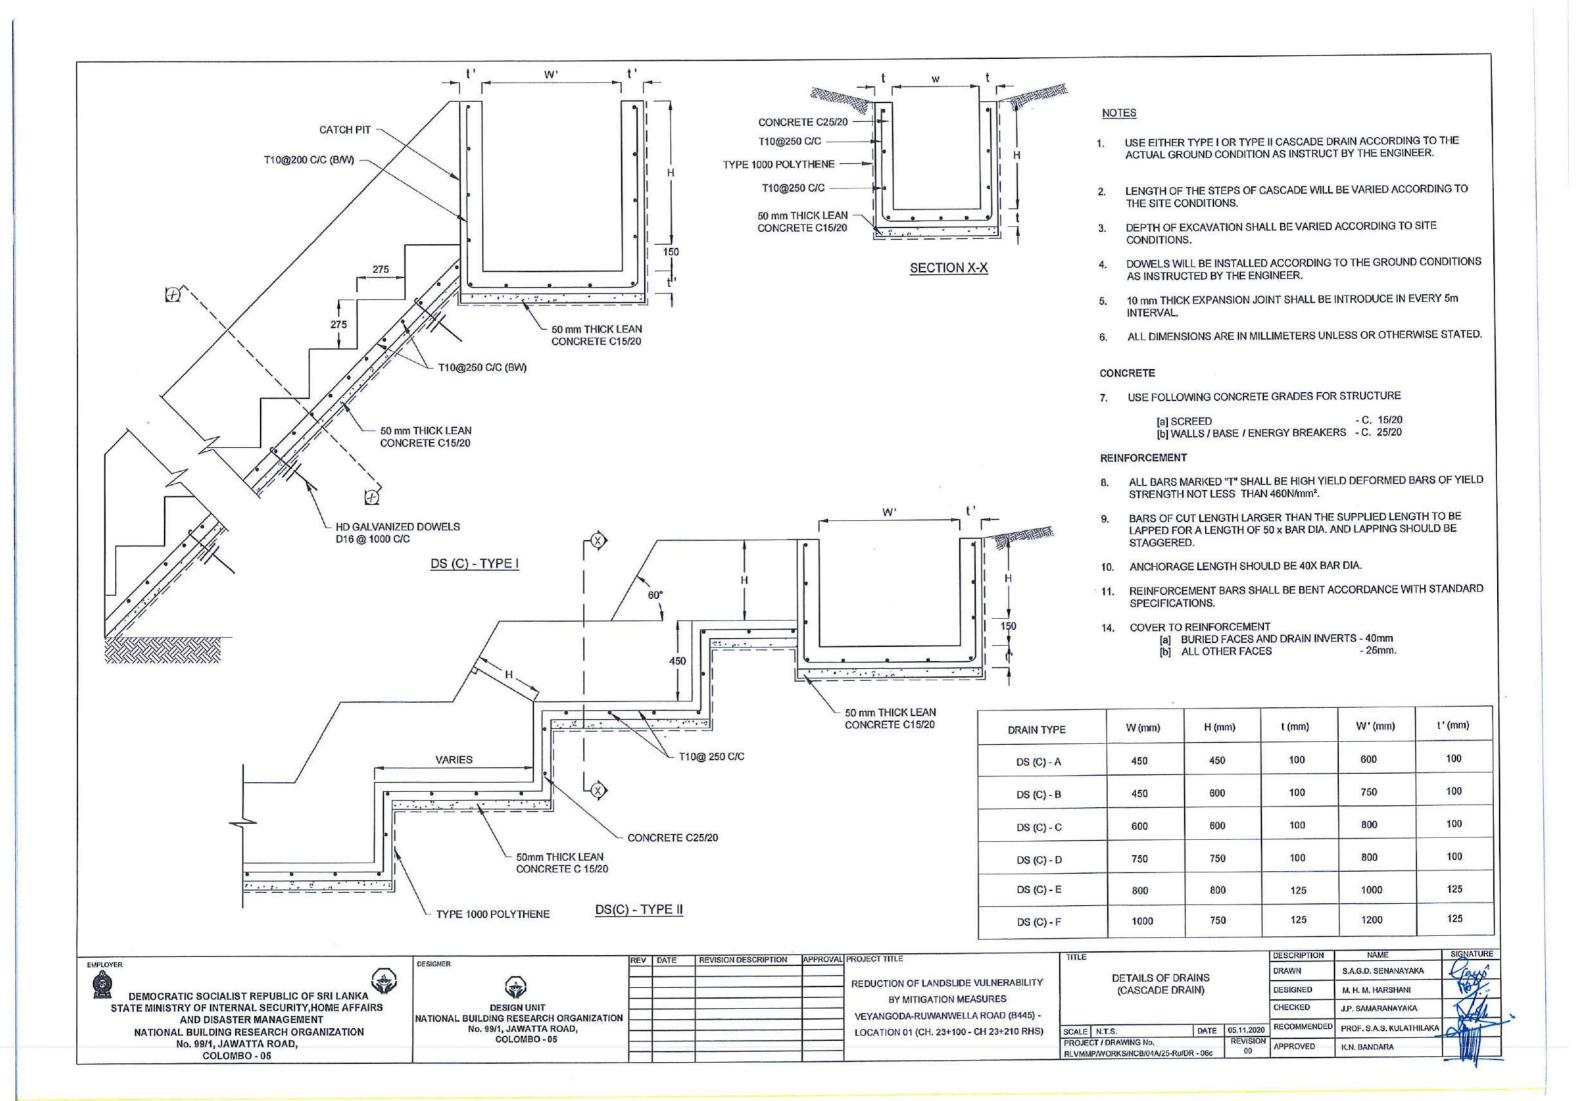

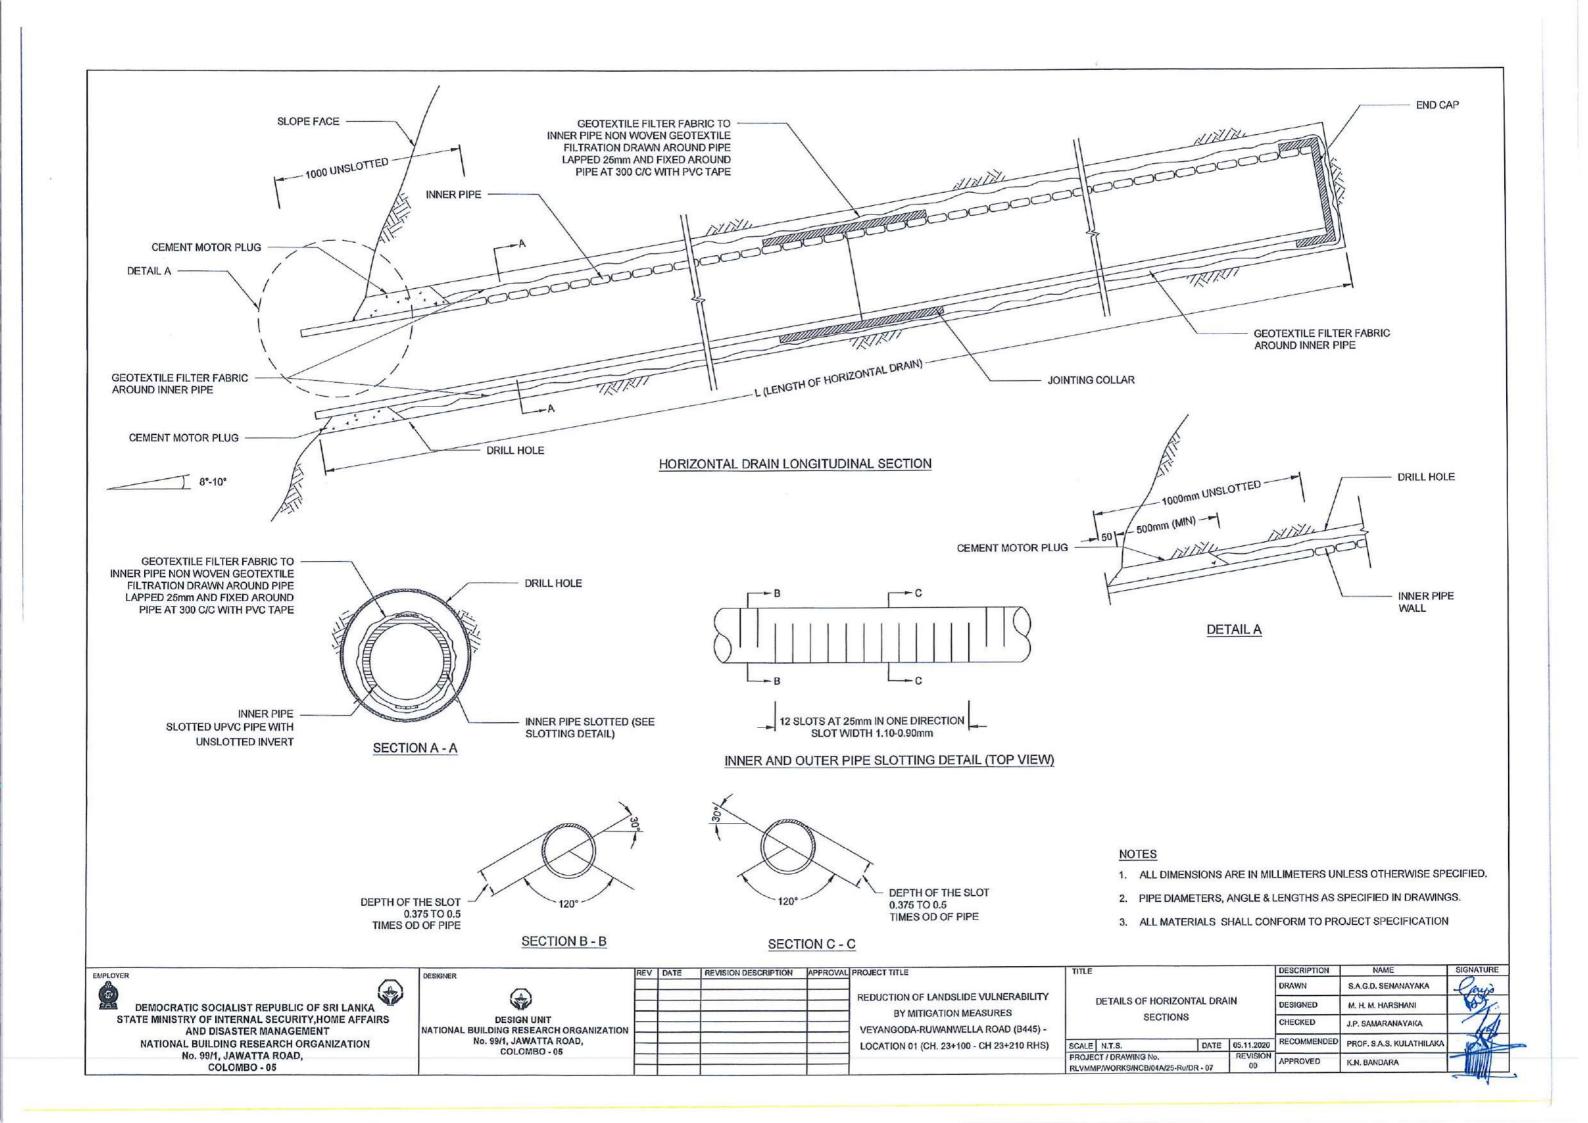


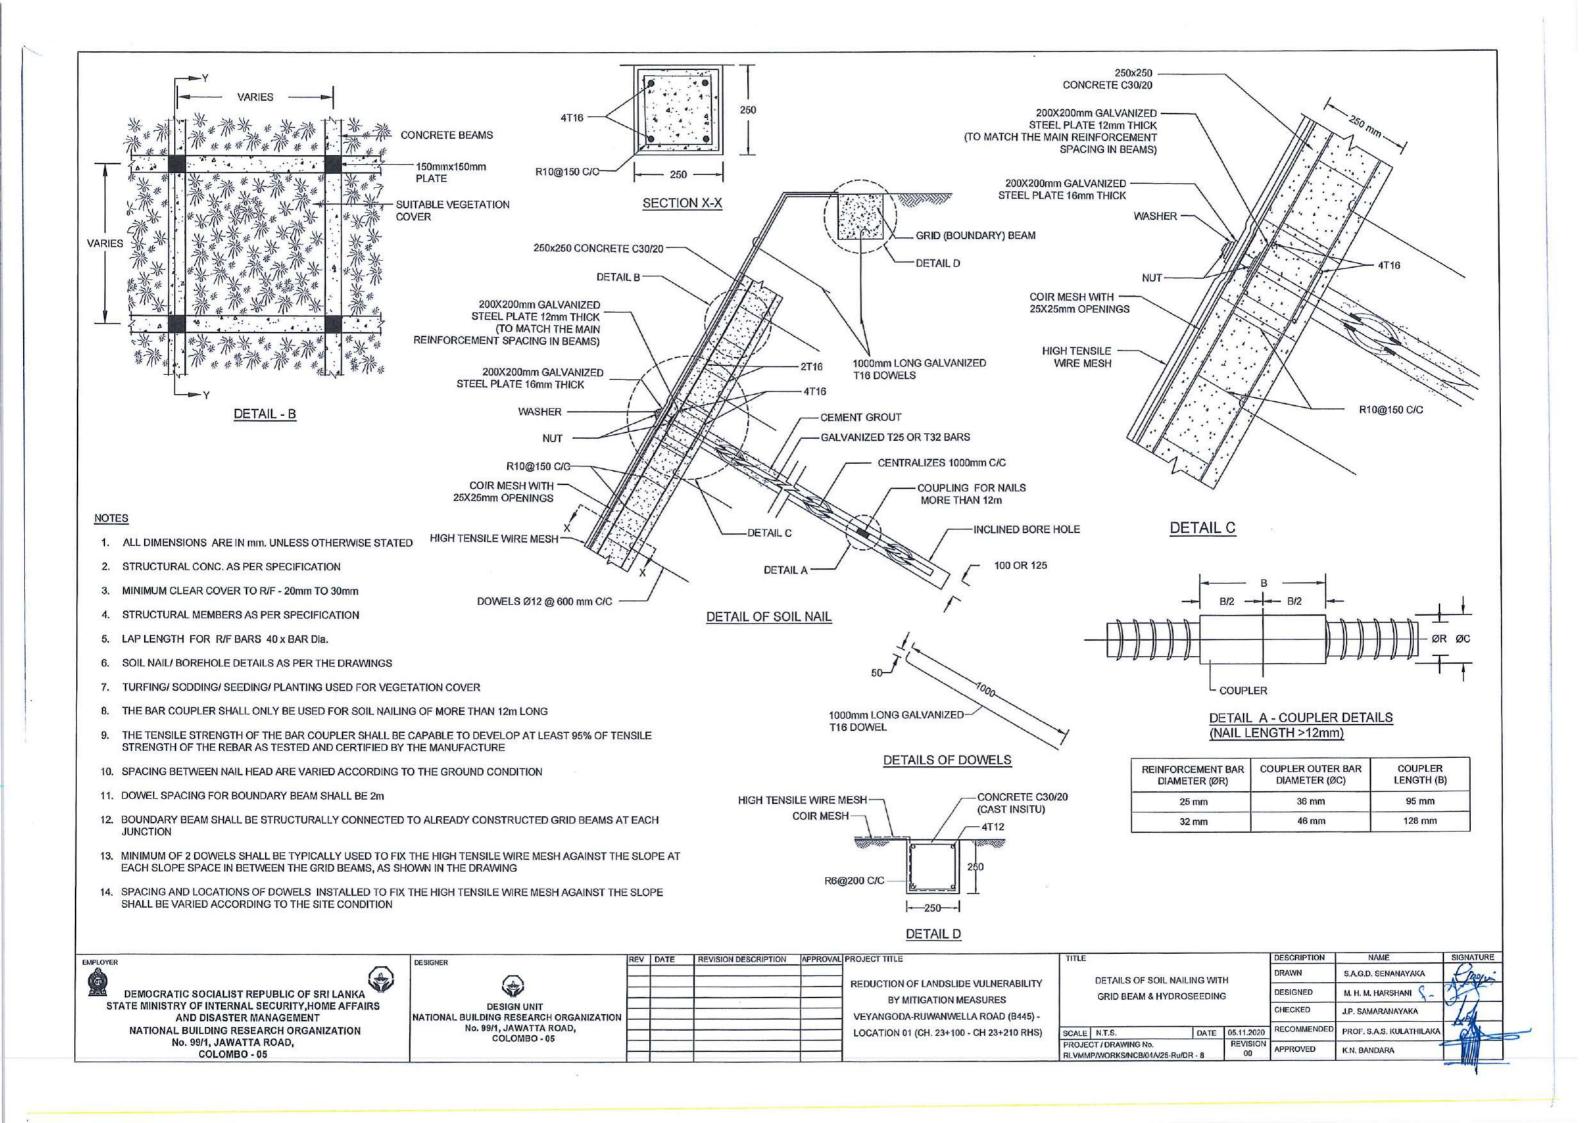

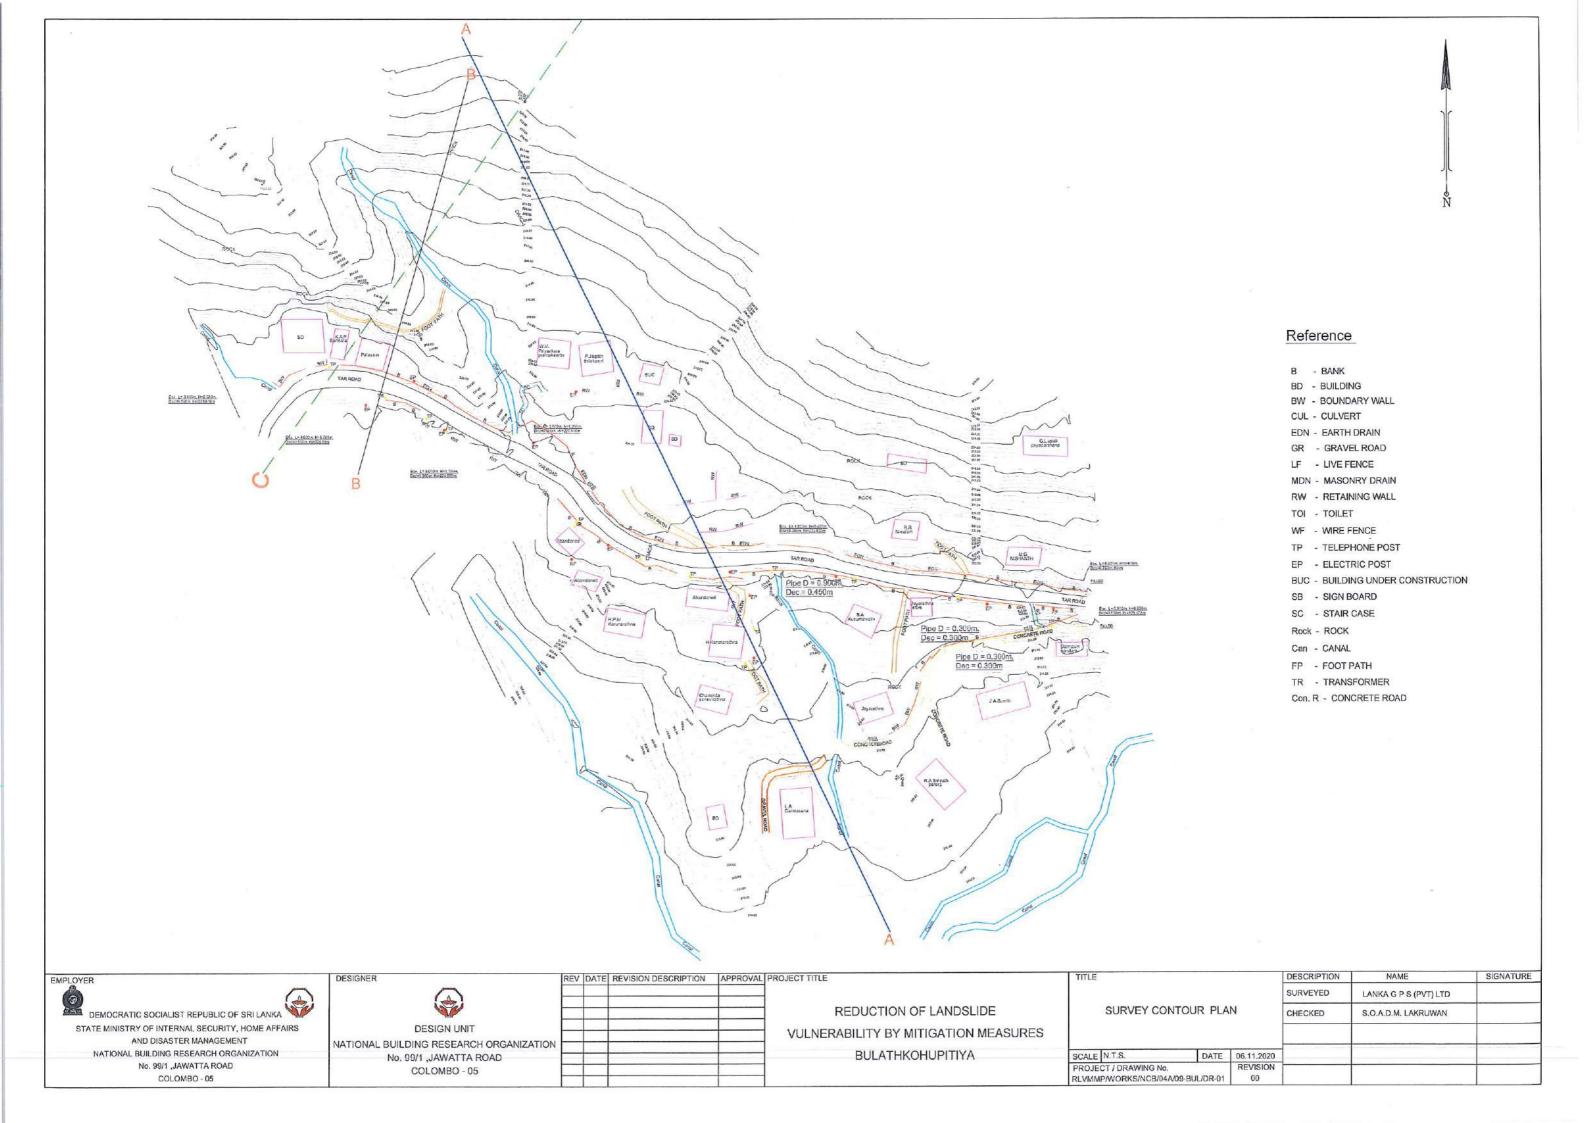

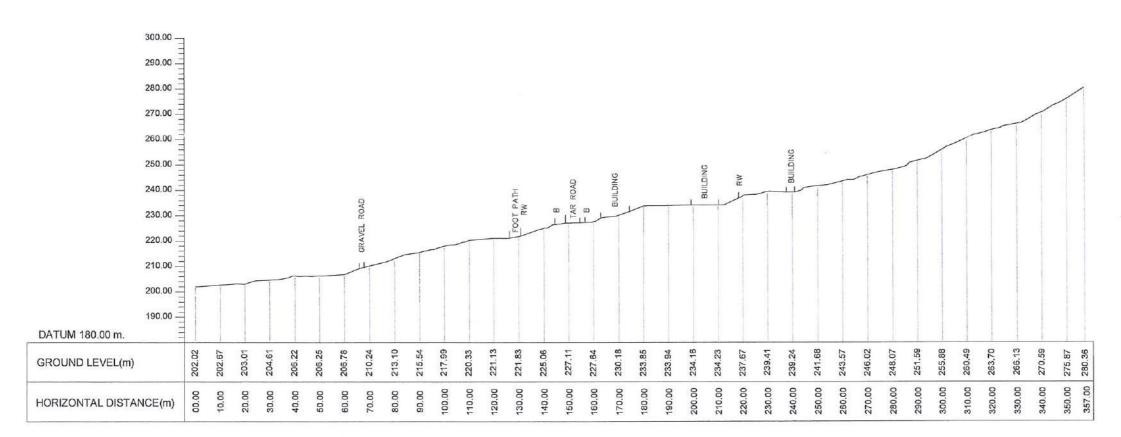



SECTION A - A

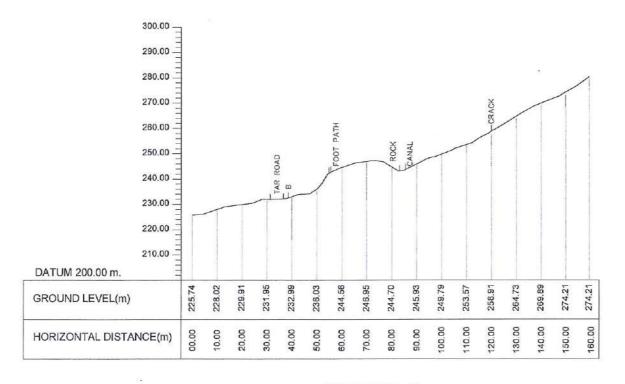

SECTION B - B

SIGNATURE DESIGNER REV DATE REVISION DESCRIPTION | APPROVAL PROJECT TITLE DESCRIPTION NAME EMPLOYER SURVEYED DEMOCRATIC SOCIALIST REPUBLIC OF SRI LANKA LANKA G P S (PVT) LTD REDUCTION OF LANDSLIDE SURVEY CROSS SECTIONS CHECKED S.O.A.D.M. LAKRUWAN STATE MINISTRY OF INTERNAL SECURITY, HOME AFFAIRS DESIGN UNIT VULNERABILITY BY MITIGATION MEASURES AND DISASTER MANAGEMENT NATIONAL BUILDING RESEARCH ORGANIZATION NATIONAL BUILDING RESEARCH ORGANIZATION BULATHKOHUPITIYA No. 99/1 ,JAWATTA ROAD DATE 06.11.2020 No. 99/1 ,JAWATTA ROAD PROJECT / DRAWING No. REVISION COLOMBO - 05 COLOMBO - 05 RLVMMP/WORKS/NCB/04A/09-BUL/DR-02

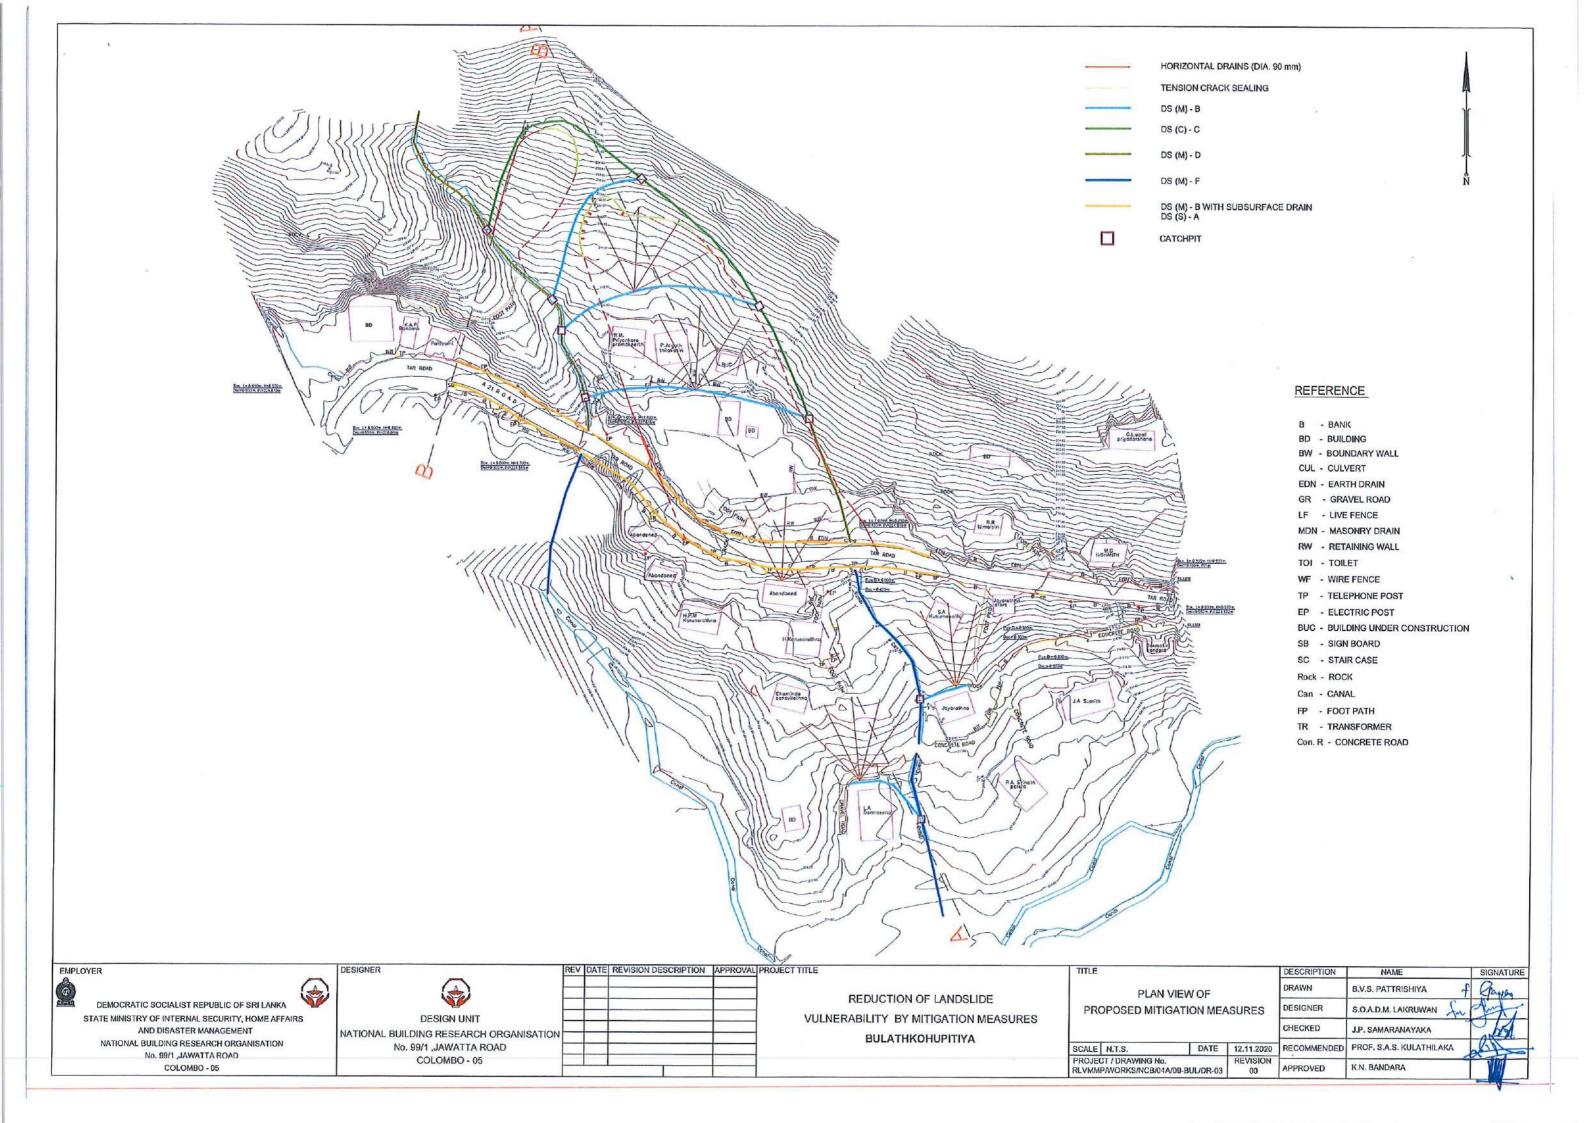

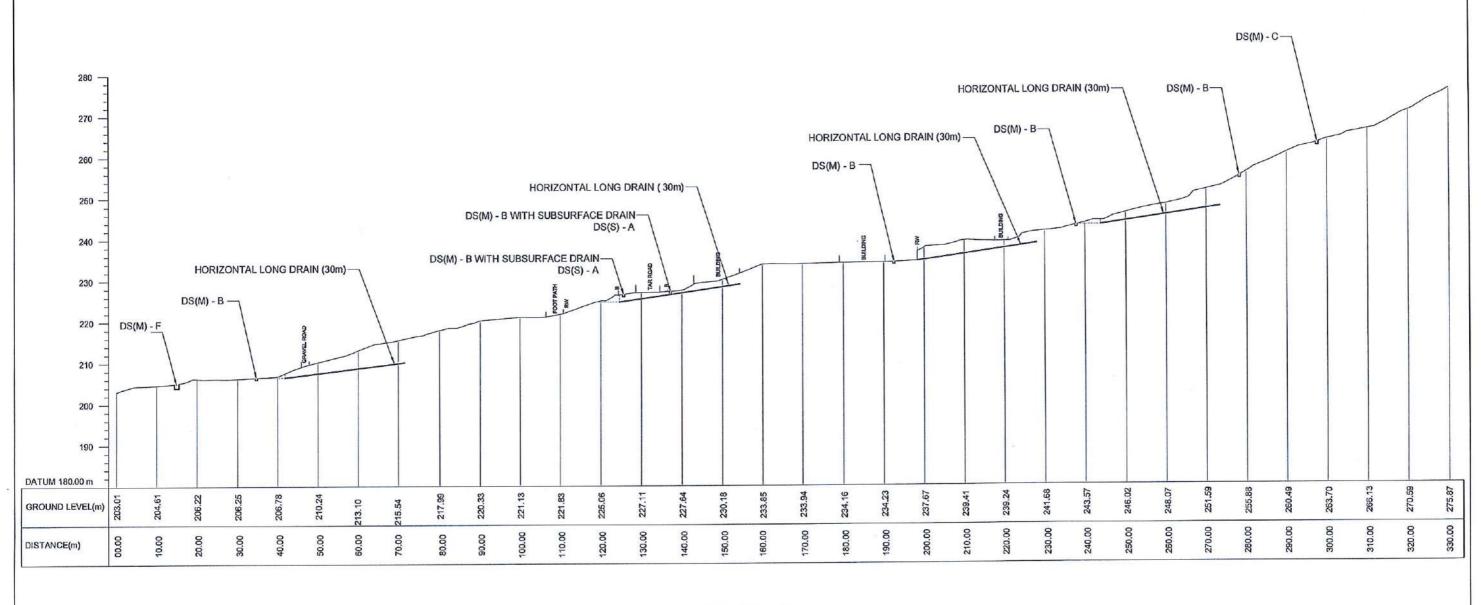


SECTION A - A


NOTE:


 LOCATION AND LENGTH OF HORIZONTAL LONG DRAINS MIGHT BE VARIED ACCORDING TO THE ACTUAL SOIL PROFILE AND SITE CONDITION.

SIGNATURE DESCRIPTION REV DATE REVISION DESCRIPTION | APPROVAL PROJECT TITLE DESIGNER EMPLOYER B.V.S. PATTRISHIYA REDUCTION OF LANDSLIDE DESIGN CROSS SECTION OF S.O.A.D.M. LAKRUWAN DESIGNER DEMOCRATIC SOCIALIST REPUBLIC OF SRI LANKA PROPOSED MITIGATION MEASURES STATE MINISTRY OF INTERNAL SECURITY, HOME AFFAIRS **DESIGN UNIT VULNERABILITY BY MITIGATION MEASURES** J.P. SAMARANAYAKE CHECKED AND DISASTER MANAGEMENT NATIONAL BUILDING RESEARCH ORGANIZATION RECOMMENDED PROF. S. A. S. KULATHILAKA BULATHKOHUPITIYA DATE 06.11.2020 NATIONAL BUILDING RESEARCH ORGANIZATION SCALE N.T.S. No. 99/1 ,JAWATTA ROAD No. 99/1 ,JAWATTA ROAD PROJECT / DRAWING No. REVISION APPROVED COLOMBO - 05 RLVMMP/WORKS/NCB/04A/09-BUL/DR-04 00 COLOMBO - 05

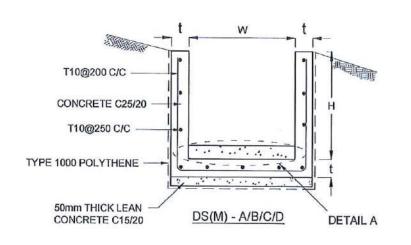

| DRAIN TYPE | W (mm) | H (mm) | t (mm) |
|---------------|--------|--------|--------|
| DS (M) - A /P | 300 | 300 | 100 |
| DS (M) - B/R | 450 | 450 | 100 |
| DS (M) - C/Q | 600 | 600 | 100 |
| DS (M) - D | 750 | 750 | 125 |
| DS (M) - E | 900 | 900 | 150 |
| DS (M) - F | 1000 | 1000 | 150 |

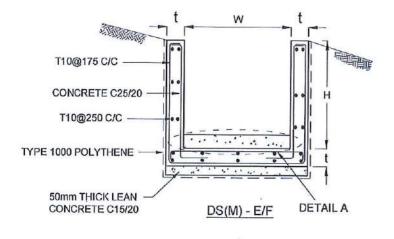

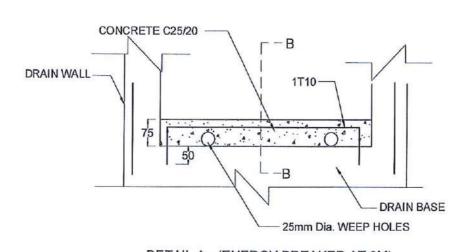

DETAIL A - (ENERGY BREAKER AT 3M)

NOTES


- 1. DEPTH OF EXCAVATION MAY VARY ACCORDING TO SITE CONDITIONS.
- STEPS SHALL BE CONSTRUCTED AT SURFACE DRAIN ON SLOPING GROUND ACCORDING TO THE SITE CONDITIONS AS INSTRUCTED BY THE ENGINEER.
- 3. ENERGY BREAKERS SHALL BE CONSTRUCTED AT THE STEEP DRAIN SEGMENTS AS PER THE INSTRUCTIONS OF THE ENGINEER.
- DOWELS SHALL BE INSTALLED ACCORDING TO THE GROUND CONDITIONS AS INSTRUCTED BY THE ENGINEER.
- 5. ALL DIMENSIONS ARE IN MILLIMETERS UNLESS OTHERWISE STATED.
- 10 mm THICK EXPANSION JOINT SHALL BE INTRODUCED IN EVERY 5m INTERVAL.


CONCRETE


- 7. USE FOLLOWING CONCRETE GRADES FOR STRUCTURE
 - a] SCREED -C. 15/20
 - [b] WALLS / BASE / ENERGY BREAKERS C. 25/20

REINFORCEMENT

- ALL BARS MARKED "T" SHALL BE HIGH YIELD DEFORMED BARS OF YIELD STRENGTH NOT LESS THAN 460N/mm².
- BARS OF CUT LENGTH LARGER THAN THE SUPPLIED LENGTH TO BE LAPPED FOR A LENGTH OF 50 x BAR DIA. AND LAPPING SHOULD BE STAGGERED.
- 10. ANCHORAGE LENGTH SHOULD BE 40X BAR DIA.
- REINFORCEMENT BARS SHALL BE BENT IN ACCORDANCE WITH STANDARD SPECIFICATIONS.
- 12. COVER TO REINFORCEMENT
 - [a] BURIED FACES AND DRAIN INVERTS 40 mm
 - ALL OTHER FACES 25 mm

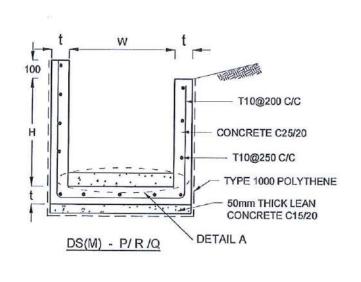


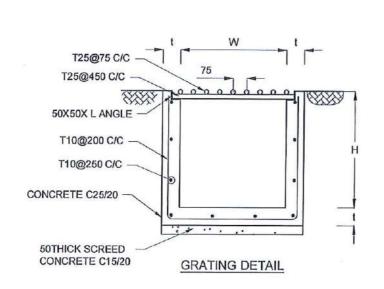

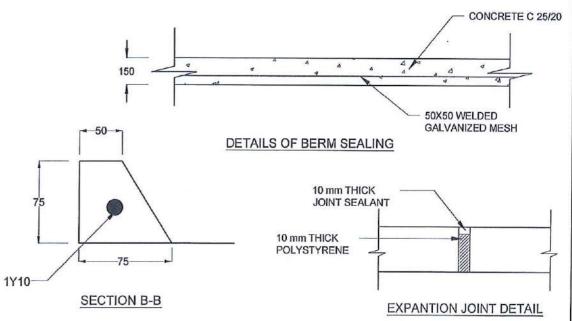



COLOMBO - 05

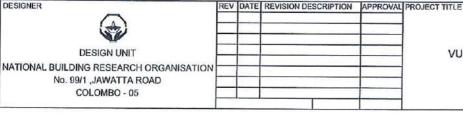

REDUCTION OF LANDSLIDE
VULNERABILITY BY MITIGATION MEASURES
BULATHKOHUPITIYA

DESCRIPTION DRAWN B.V.S. PATTRISHIYA **DETAILS OF DRAINS** DESIGNER (SURFACE DRAIN) S.O.A.D.M. LAKRUWAN CHECKED J.P. SAMARANAYAKA PROF. S.A.S. KULATHILAKA SCALE N.T.S. DATE 12.11.2020 RECOMMENDED PROJECT / DRAWING No.
RLVMMP/WORKS/NCB/04A/09-BUL/DR-05a REVISION APPROVED K.N. BANDARA

